
# CHERAW HOUSING AUTHORITY SEWER LINE REPLACEMENT & INTERIOR RENOVATIONS

# CONSTRUCTION DOCUMENTS JUNE 19, 2025


PROJECT NO: 04-2024-07.01

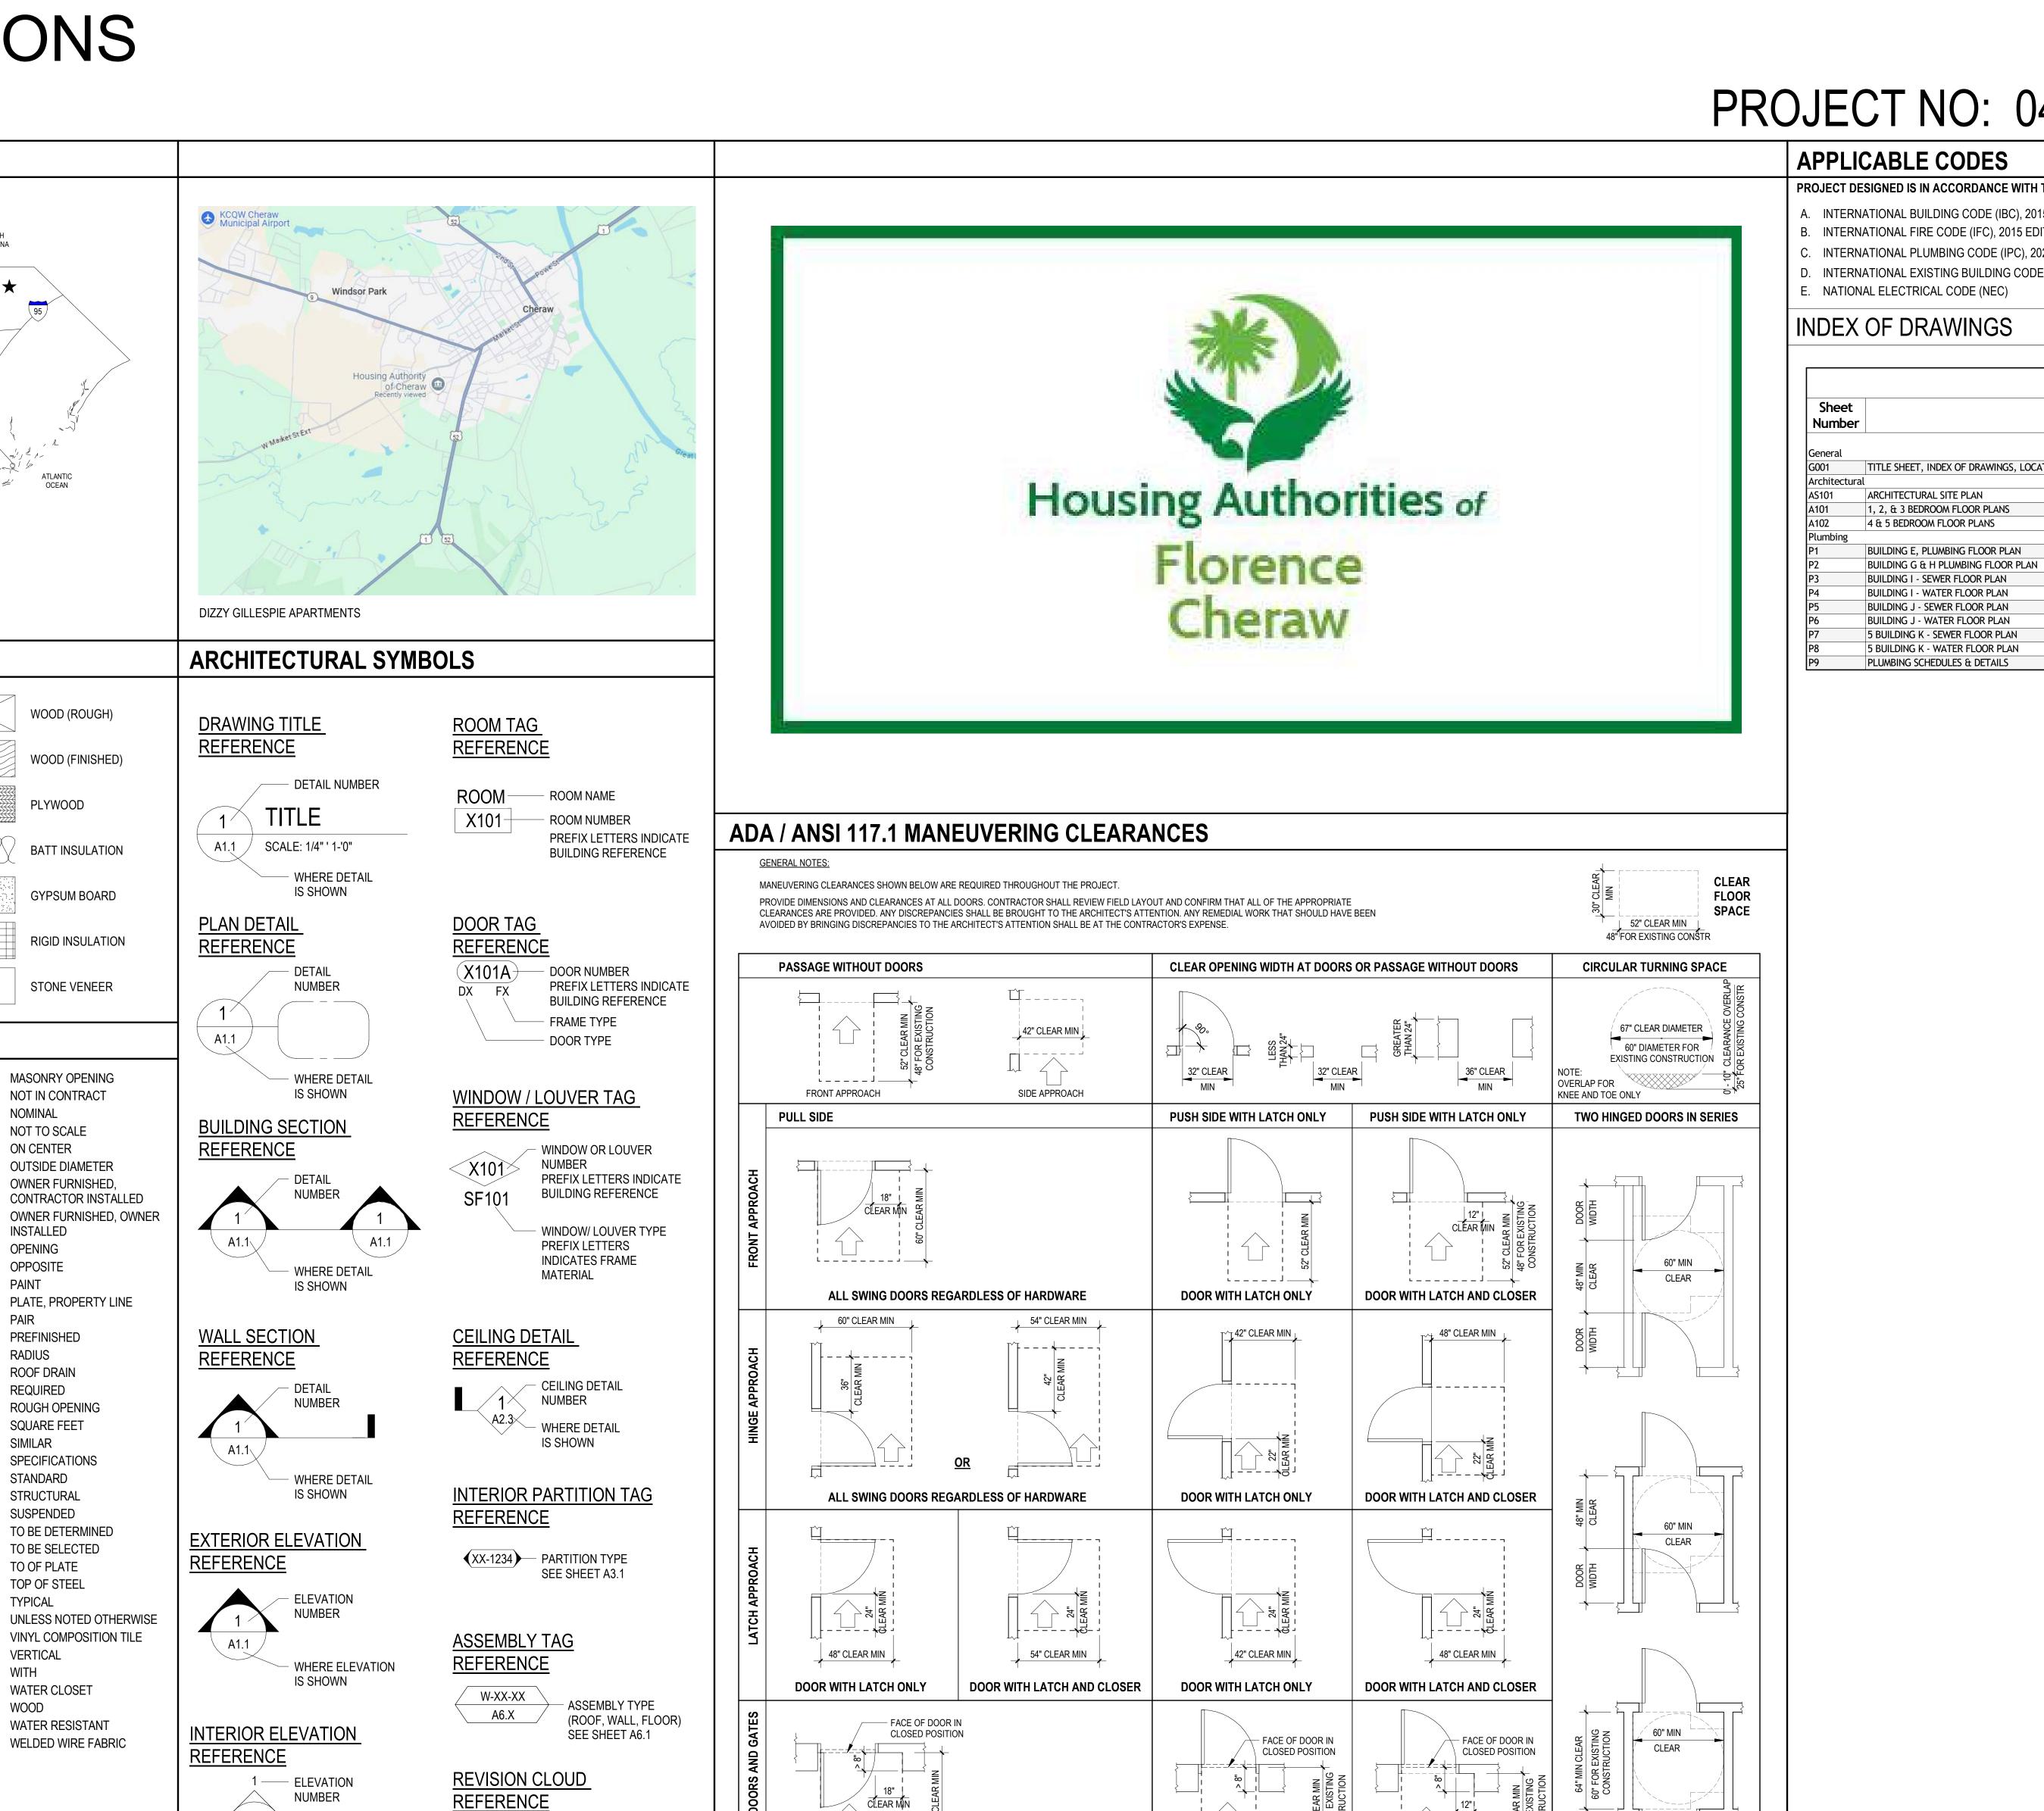


ALL SWING DOORS REGARDLESS OF HARDWARE

**DOOR WITH LATCH AND CLOSER** 

DOOR WITH LATCH ONLY

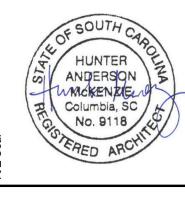

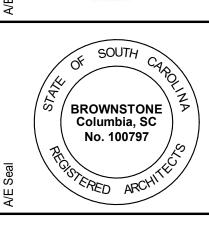

HOUSING

Description

**G001** 

MFR

MIN

MATERIAL DESIGNATIONS

COMPACTED EARTH

SAND, PLASTER, CEMENT,

**ABBREVIATIONS** 

**ARCHITECTURAL** 

CONTROL JOINT

CENTER LINE

CEILING

CONCRETE

CENTER **DIAMETER** 

**DOWNSPOU** 

DRAWING

**ELEVATION** 

**ELECTRICAL** 

**ELEVATOR** 

**EQUIPMENT** 

EXISTING

**EXTERIOR** 

FINISH

**FLOOR DRAIN** 

FACE OF FINISH

FACE OF STUD FIRE RETARDENT

FIELD VERIFY

**GYPSUM BOARD** 

HOLLOW METAL

HEATING VENTILATION

INSIDE DIAMETER

INSULATION

**ANGLE LAVATORY** 

MAXIMUM

MINIMUM

**MECHANCIAL** 

**MANUFACTURER** 

**HORIZONTAL** 

**EXPANSION JOINT** 

**ELECTRIC WATER COOLER** 

EACH

CONTINUOUS

CONC

CONT

CONTRACTOR FURNISHED.

CONTRACTOR INSTALLED

CONRETE MASONRY UNIT

**PLYWOOD** 

NOT IN CONTRACT

NOT TO SCALE

ON CENTER

**INSTALLED** 

**ROOF DRAIN** 

**ROUGH OPENING** 

**SPECIFICATIONS** 

SQUARE FEET

REQUIRED

SIMILAR

STANDARD

STRUCTURAL

SUSPENDED

TO OF PLATE

TOP OF STEEL

WATER CLOSET

— REVISION

NUMBER

WHERE ELEVATION

VCT

TO BE SELECTED

PAINT

2 BEDROOM UNITS

TOTALS

GENERAL NOTE: REPLACE ALL INTERIOR DRAIN / SEWER LINES & WATER LINES, AND PROVIDE SCHEDULED INTERIOR RENOVATIONS TO ALL UNITS, THE OFFICE AND COMMUNITY BUILDING.

NUMBER OF BEDROOMS # BLDGS. DWELLING UNIT
1 BEDROOM UNITS 1 1336

5 BEDROOM UNITS 1 1368


GILLESPIE BUILDING SCHEDULE

3 BEDROOM UNITS 10 57, 73, 83, 85, 1320, 1340, 1346, 1348, 1354, 1358, 1360, 1374, 1383, 1399

2 BEDROOM UNITS 6 1305, 1307, 1355, 1363, 1377, 1380, 1382, 1389,


4 BEDROOM UNITS 5 91, 95, 1325, 1349, 1369, 1371

25 30

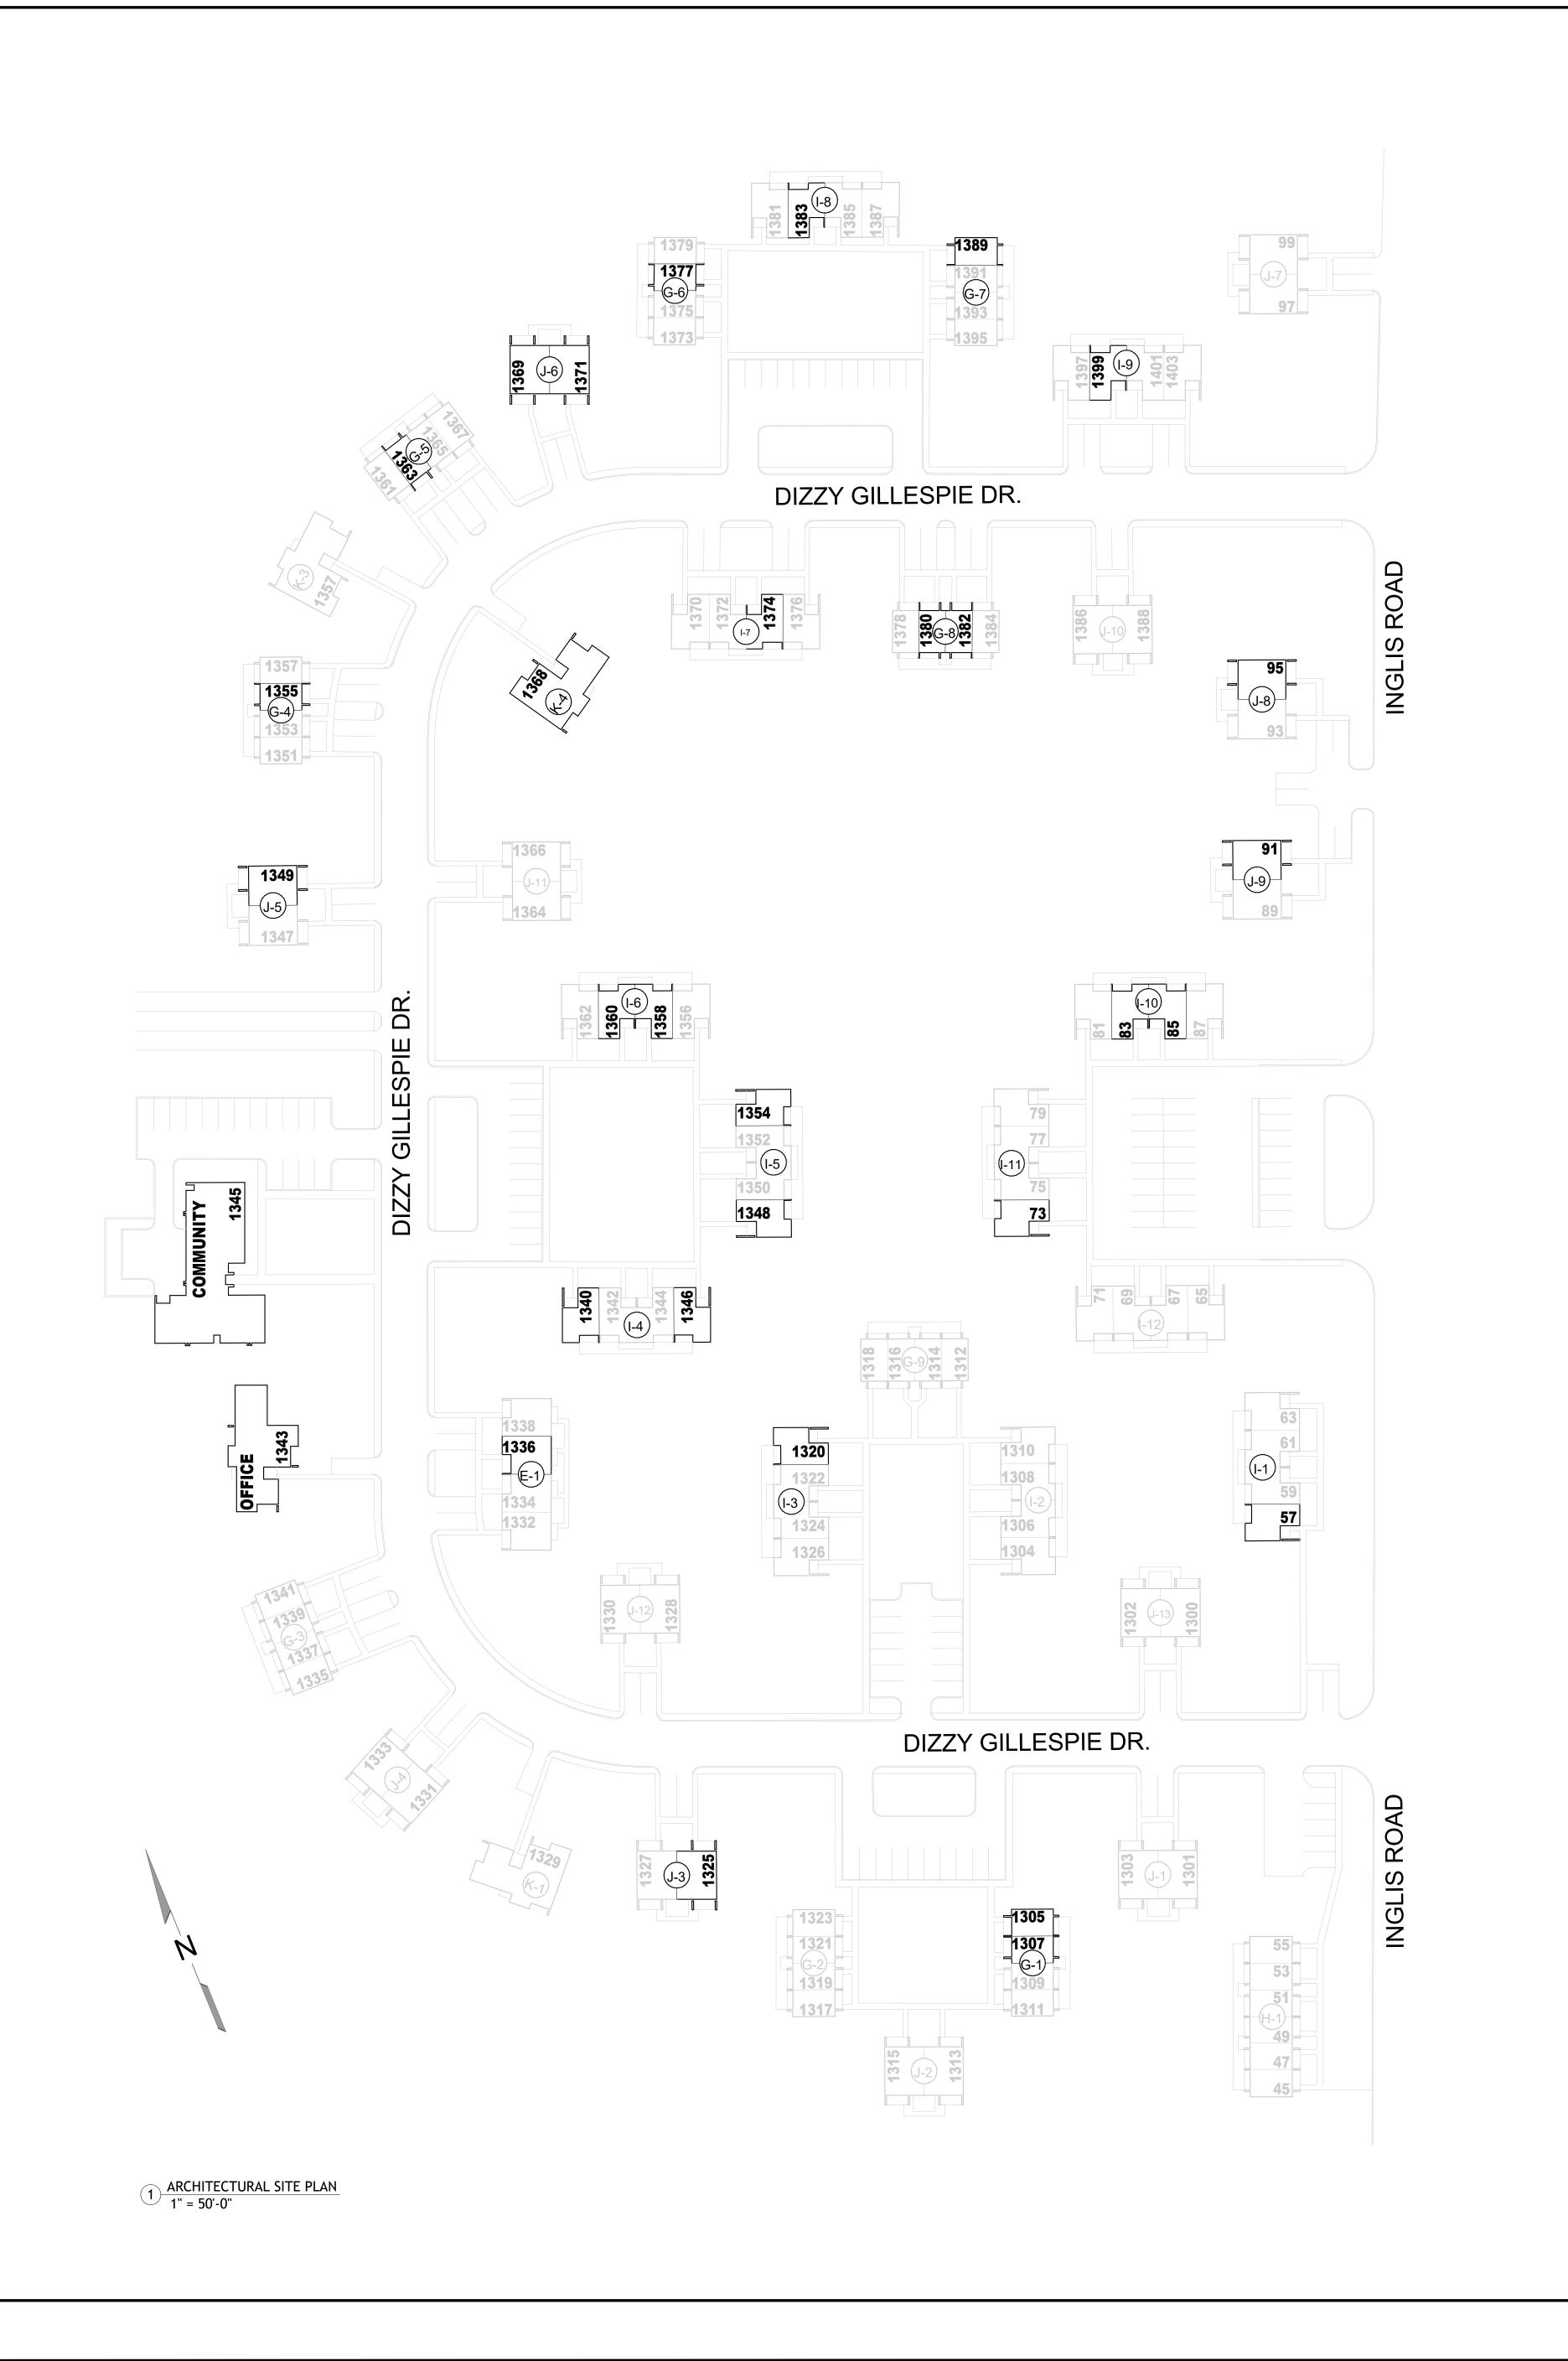

Drawing No. A101



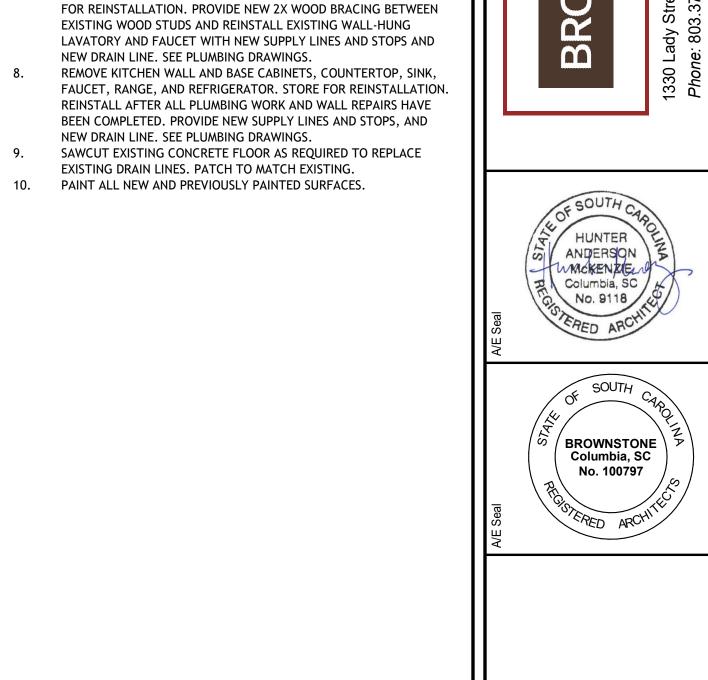

**DEMOLITION & REPAIR NOTES:** 

BOARD ON EXISTING ADJACENT SURFACES.

4. REPLACE SELECTED BATHTUBS. COORDINATE WITH PLUMBING

THE CEILING.

DRAWINGS.

22' - 4"

SAWCUT PORTION OF EXISTING CONCRETE SLAB AS INDICATED. COORDINATE WITH

PLUMBING DRAWINGS.


FLOOR PLAN ONE BEDROOM UNIT


SCALE: 1/4" 1'-0


REMOVE ONLY THE PORTION OF EXISTING FLOORING AS REQUIRED TO REPLACE THE EXISTING SEWER LINES. PATCH AS REQUIRED TO MATCH EXISTING. COORDINATE WITH PLUMBING DRAWINGS. REMOVE EXISTING GYPSUM WALL BOARD FROM THE PLUMBING WALLS AND/OR CEILING TO ALLOW ACCESS TO PIPING THAT IS TO BE REPLACED - SEE PLUMBING DRAWINGS. PROVIDE NEW GYPSUM

REMOVE EXISTING BATHTUB WALL SURROUNDS AND PROVIDE NEW BATHTUB WALL SURROUNDS. NEW TUB SURROUNDS TO EXTEND TO

REPLACE SELECTED SUBFLOORING AND FLOOR JOISTS AS REQUIRED. REPLACE EXISTING WATER CLOSET, SUPPLY LINE AND STOP, FLOOR FLANGE, WAX RING AND ANCHOR BOLTS. SEE PLUMBING DRAWINGS. REMOVE EXISTING WALL-HUNG LAVATORY AND FAUCET AND STORE

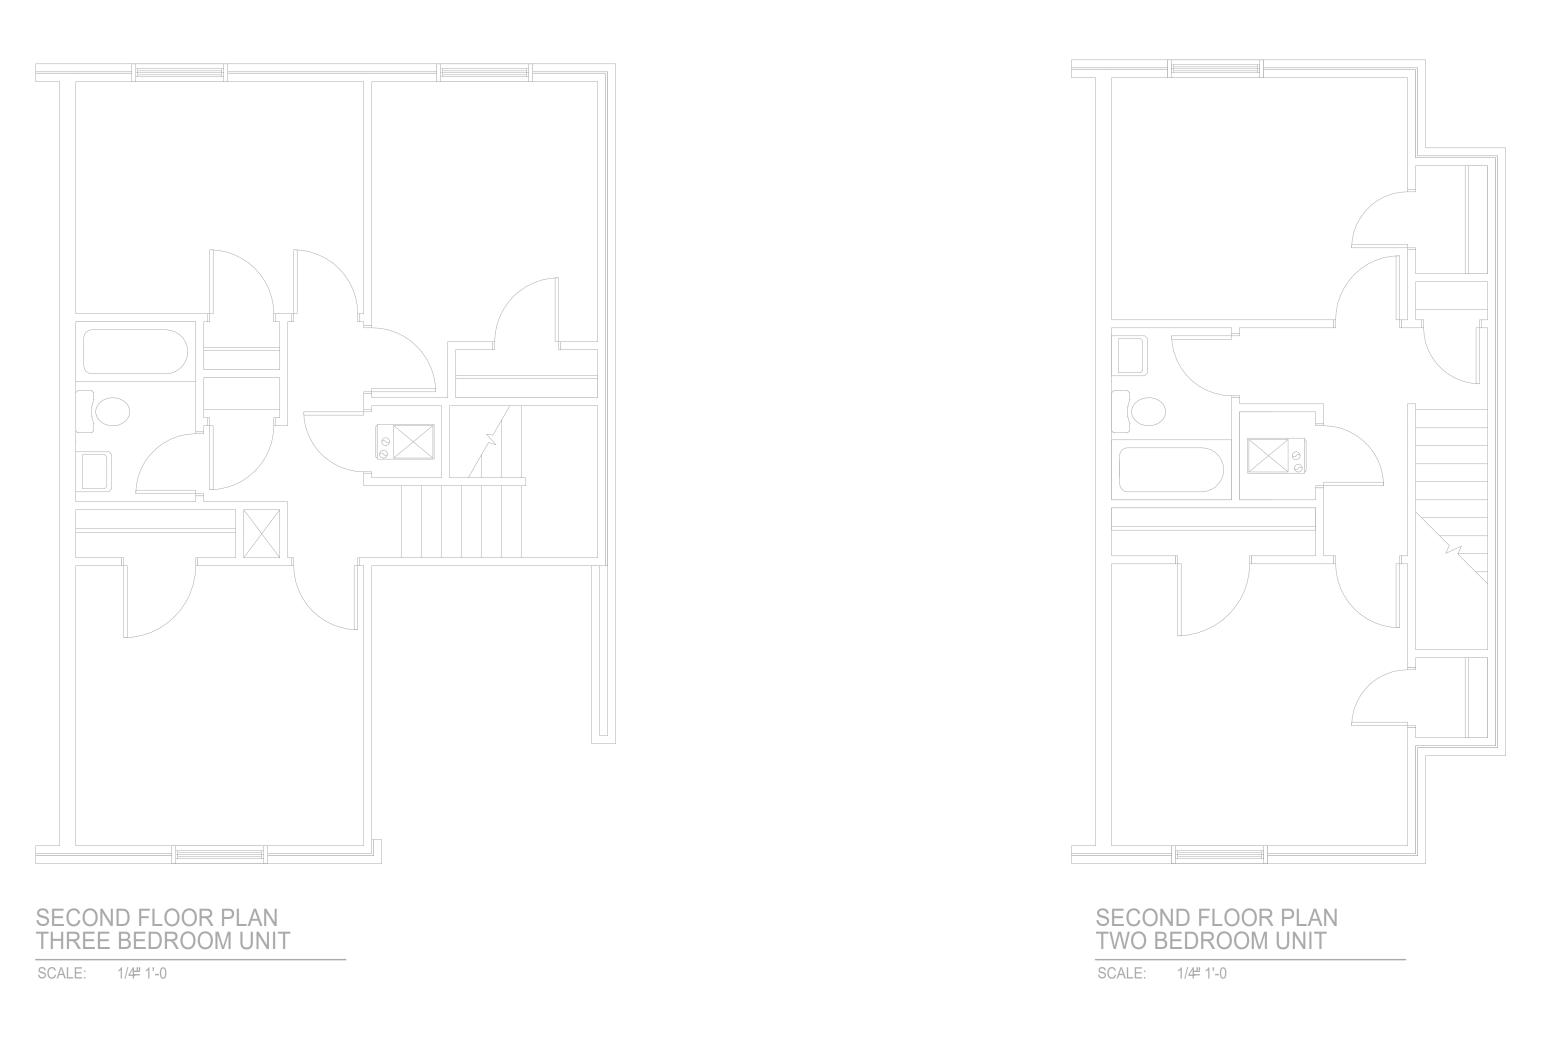

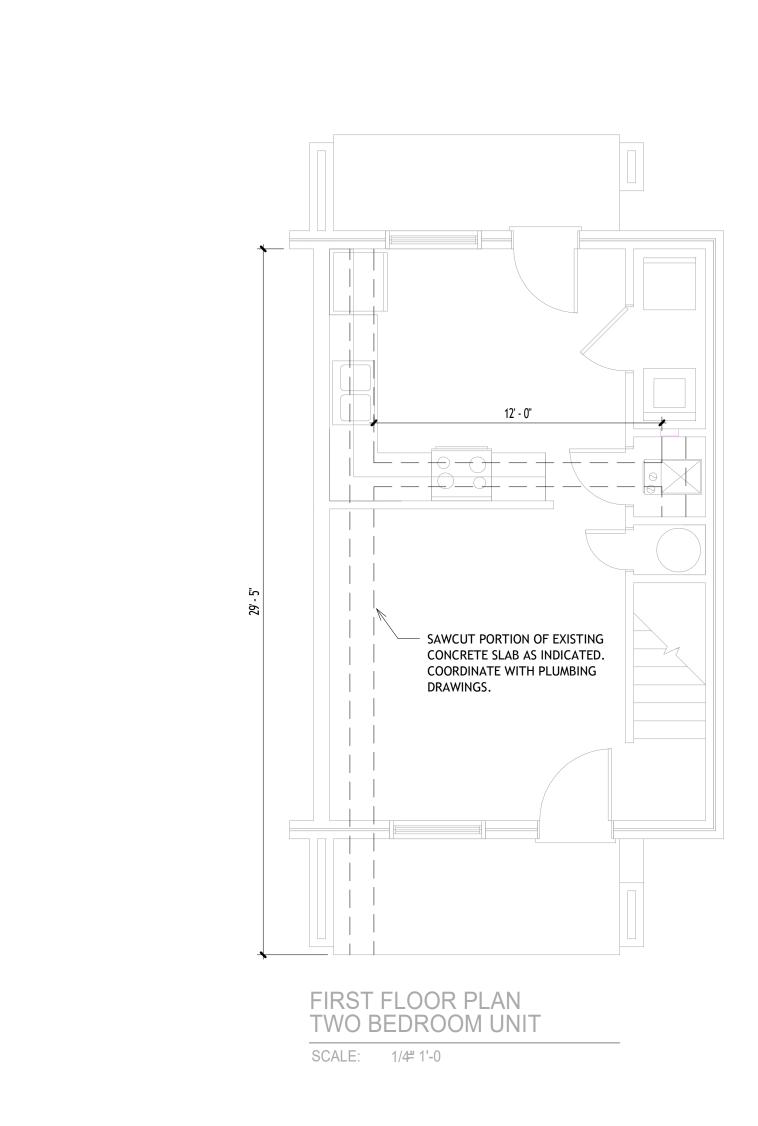

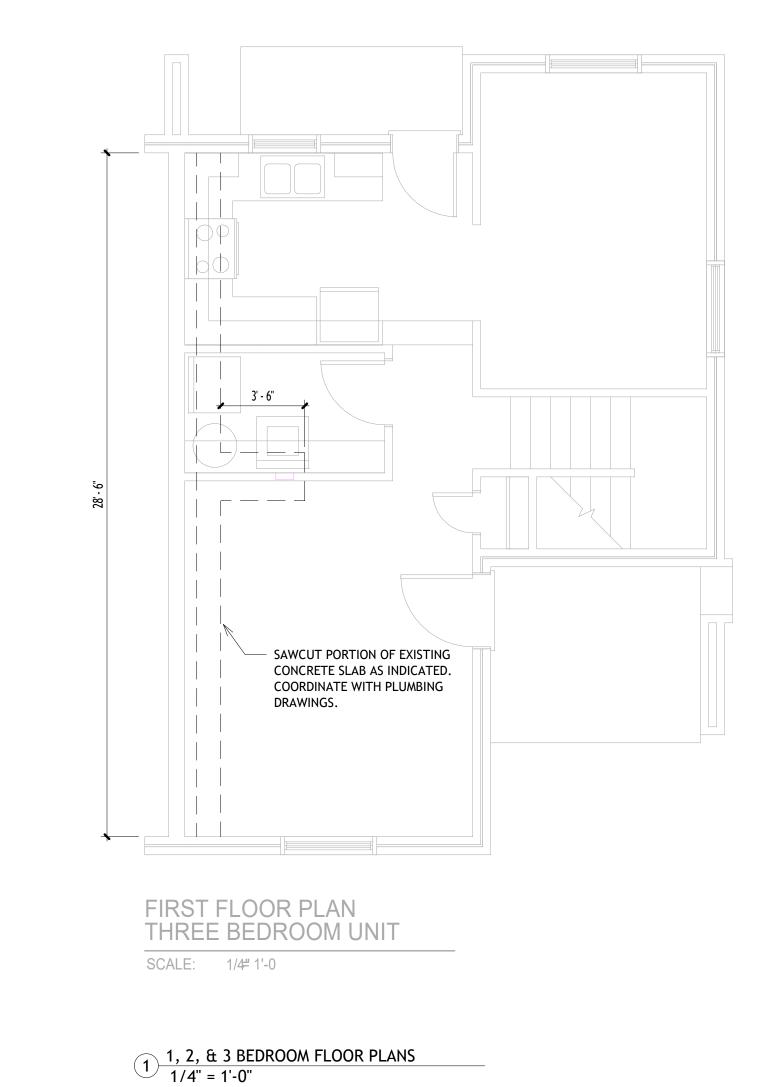

HUNTER SI ANDERSON THINCKEN KIELLY


A102

## **DEMOLITION & REPAIR NOTES:**

REMOVE ONLY THE PORTION OF EXISTING FLOORING AS REQUIRED TO REPLACE THE EXISTING SEWER LINES. PATCH AS REQUIRED TO MATCH EXISTING. COORDINATE WITH PLUMBING DRAWINGS. REMOVE EXISTING GYPSUM WALL BOARD FROM THE PLUMBING WALLS AND/OR CEILING TO ALLOW ACCESS TO PIPING THAT IS TO BE REPLACED - SEE PLUMBING DRAWINGS. PROVIDE NEW GYPSUM REMOVE EXISTING BATHTUB WALL SURROUNDS AND PROVIDE NEW

BOARD ON EXISTING ADJACENT SURFACES. BATHTUB WALL SURROUNDS. NEW TUB SURROUNDS TO EXTEND TO THE CEILING. 4. REPLACE SELECTED BATHTUBS. COORDINATE WITH PLUMBING DRAWINGS. REPLACE SELECTED SUBFLOORING AND FLOOR JOISTS AS REQUIRED.

REPLACE EXISTING WATER CLOSET, SUPPLY LINE AND STOP, FLOOR FLANGE, WAX RING AND ANCHOR BOLTS. SEE PLUMBING DRAWINGS. REMOVE EXISTING WALL-HUNG LAVATORY AND FAUCET AND STORE FOR REINSTALLATION. PROVIDE NEW 2X WOOD BRACING BETWEEN EXISTING WOOD STUDS AND REINSTALL EXISTING WALL-HUNG LAVATORY AND FAUCET WITH NEW SUPPLY LINES AND STOPS AND NEW DRAIN LINE. SEE PLUMBING DRAWINGS. REMOVE KITCHEN WALL AND BASE CABINETS, COUNTERTOP, SINK, FAUCET, RANGE, AND REFRIGERATOR. STORE FOR REINSTALLATION. REINSTALL AFTER ALL PLUMBING WORK AND WALL REPAIRS HAVE BEEN COMPLETED. PROVIDE NEW SUPPLY LINES AND STOPS, AND NEW DRAIN LINE. SEE PLUMBING DRAWINGS. 9. SAWCUT EXISTING CONCRETE FLOOR AS REQUIRED TO REPLACE EXISTING DRAIN LINES. PATCH TO MATCH EXISTING. 10. PAINT ALL NEW AND PREVIOUSLY PAINTED SURFACES.

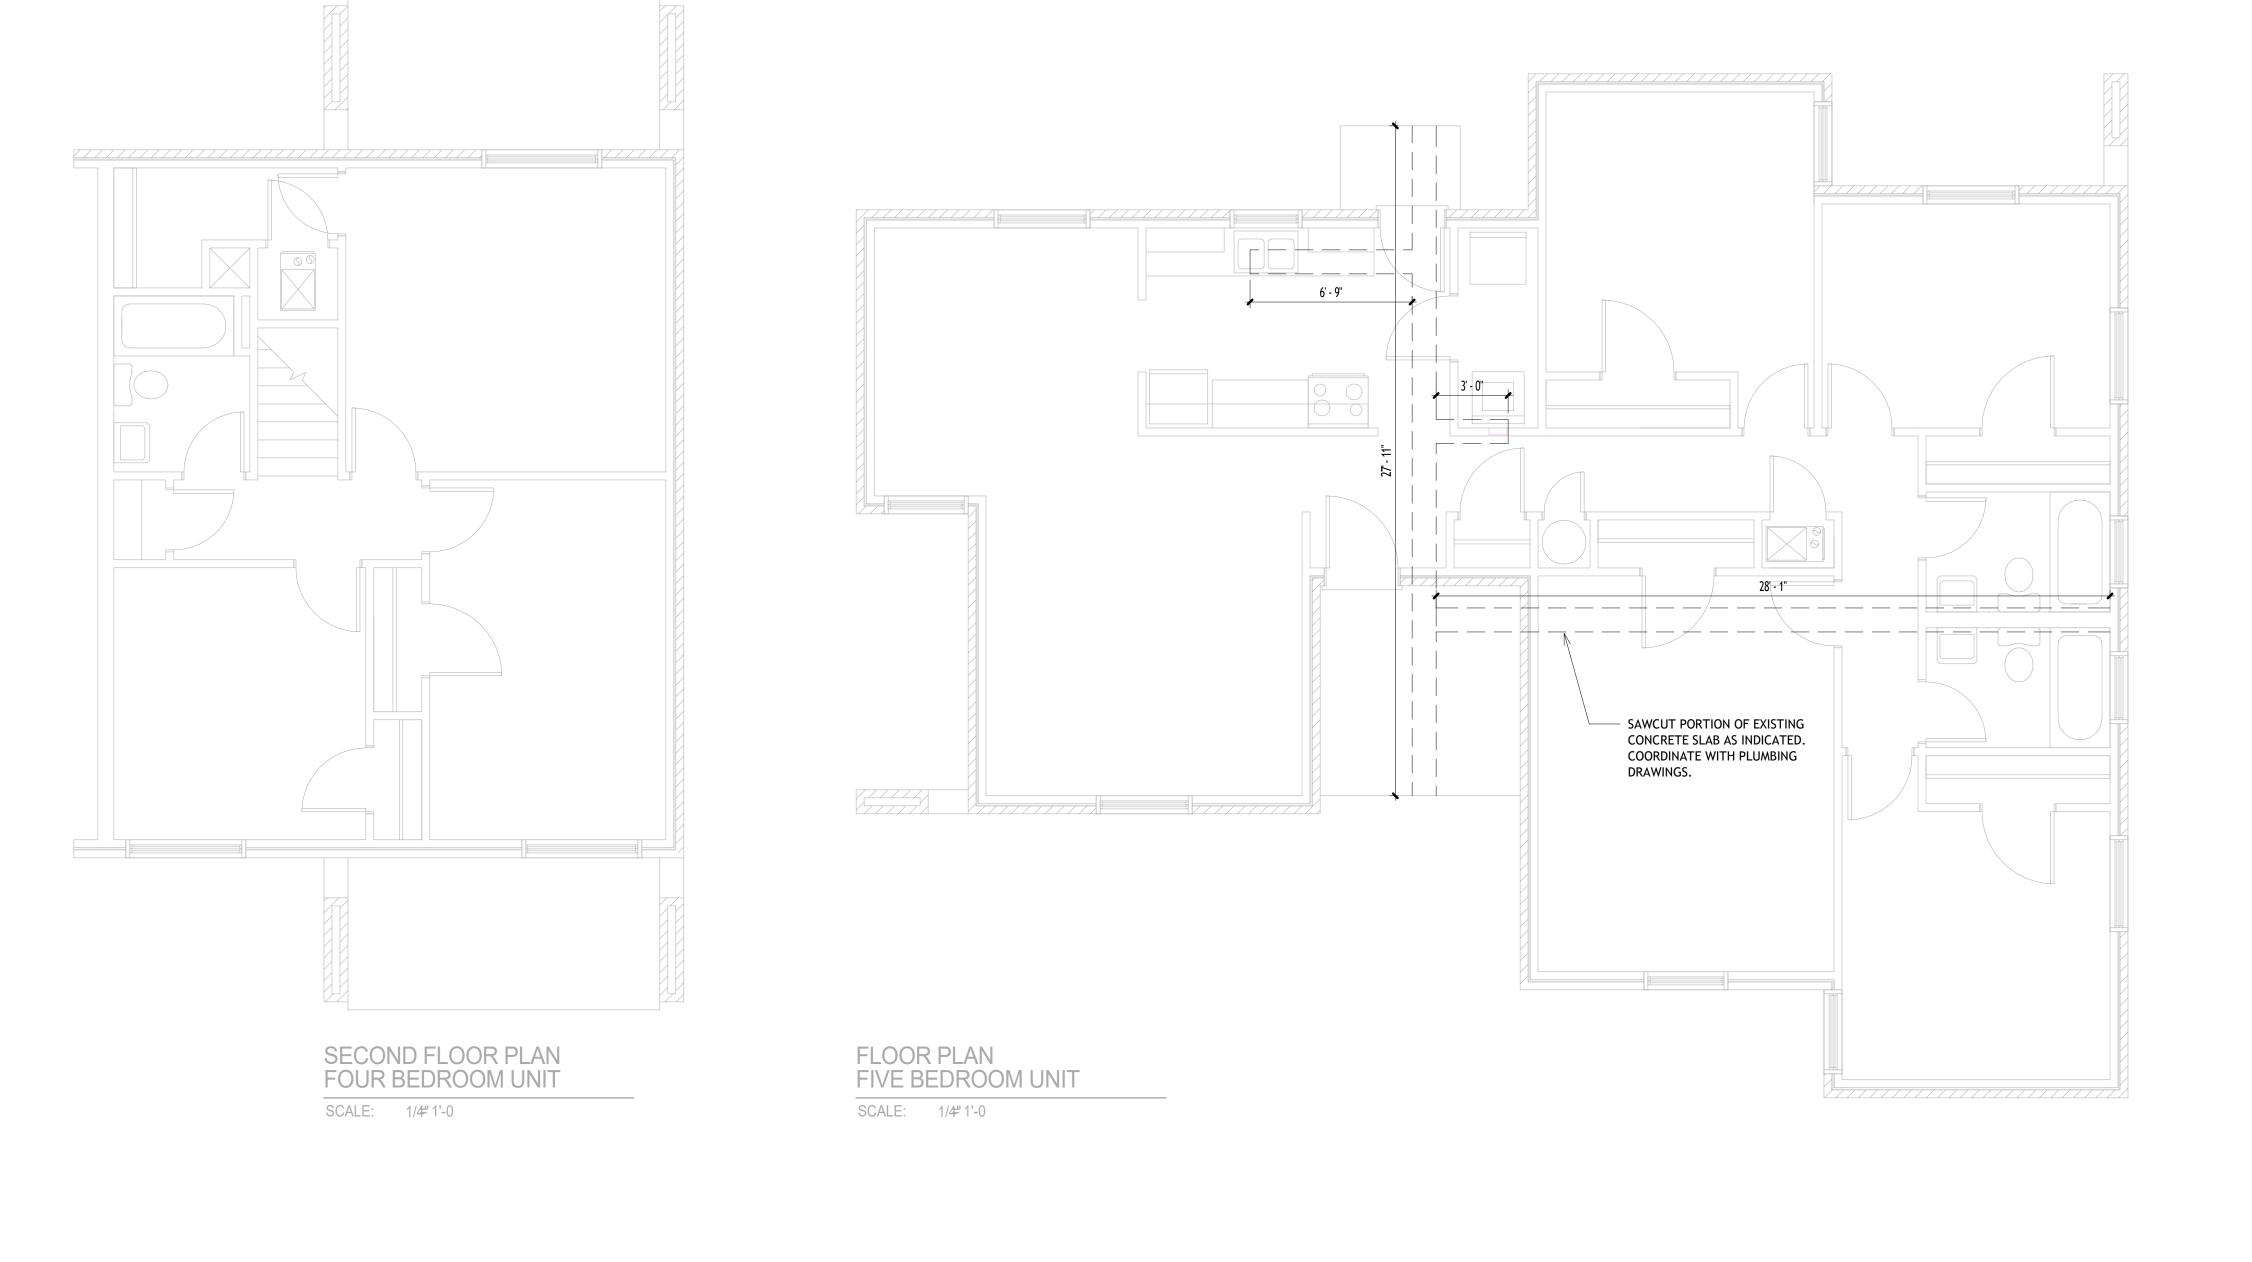



SAWCUT PORTION OF EXISTING CONCRETE SLAB AS INDICATED. COORDINATE WITH PLUMBING DRAWINGS.


FIRST FLOOR PLAN FOUR BEDROOM UNIT

SCALE: 1/4" 1'-0


1 4 & 5 BEDROOM FLOOR PLANS 1/4" = 1'-0"

# UILDIN



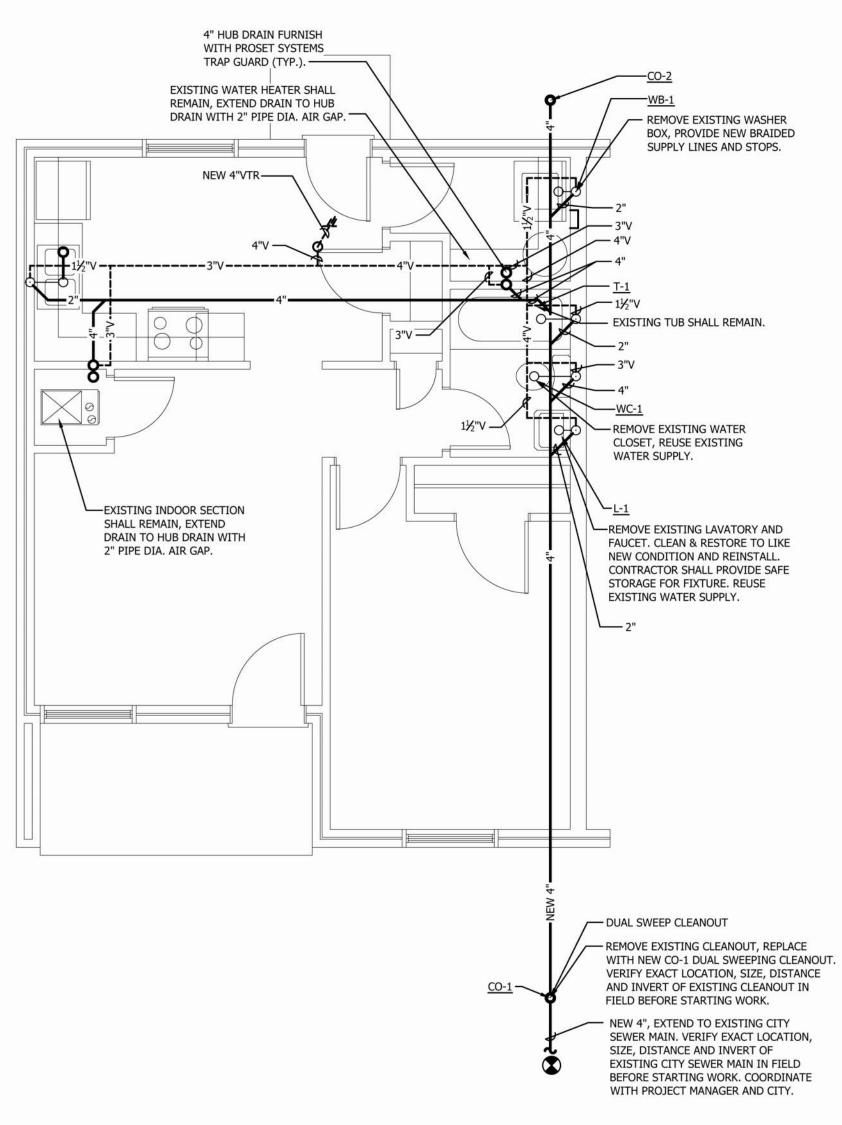

1 BR BUILDING E - SEWER FLOOR PLAN

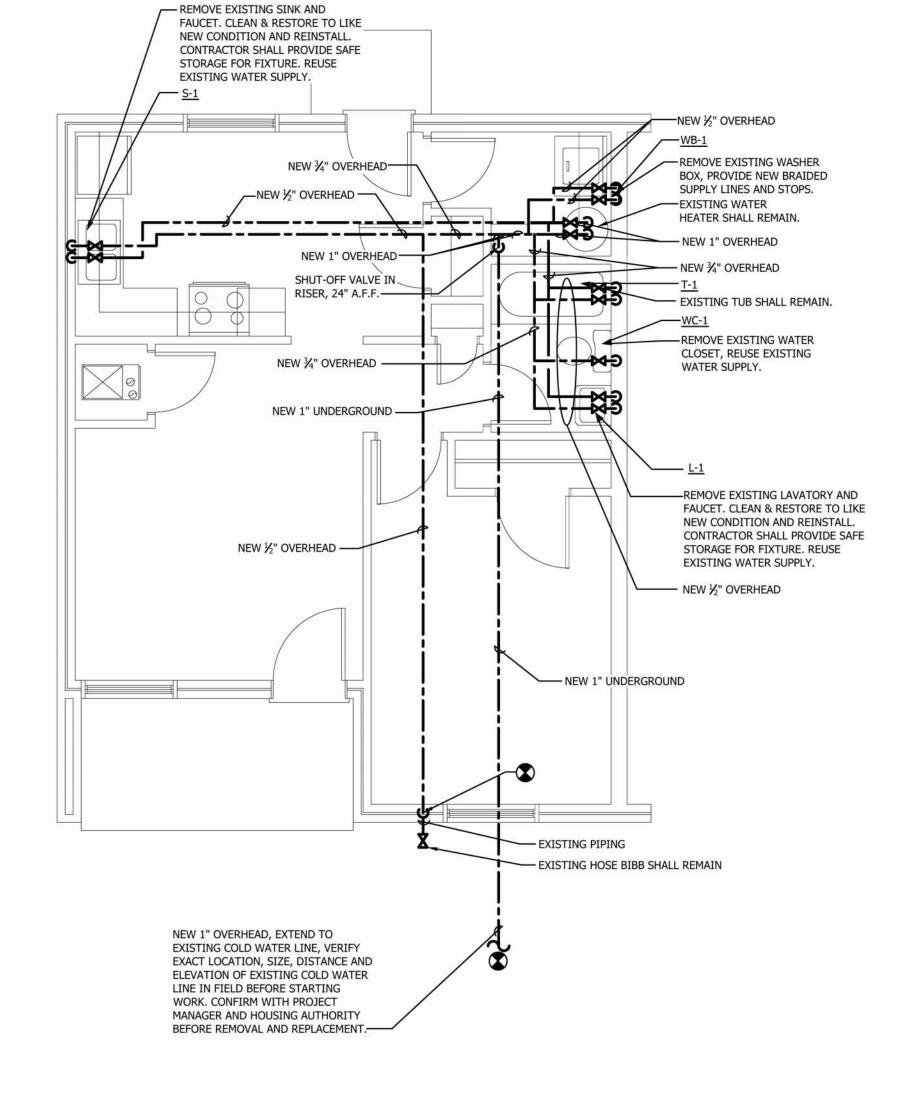

1 BR BUILDING E - WATER FLOOR PLAN

#### PLUMBING LEGEND ---- ESAN ---- EXISTING SANITARY DRAIN ———— PIPE UP ———— COLD WATER ———— PIPE UP TEE ———— PIPE DOWN ———— PIPE DOWN TEE VENT THRU ROOF FLOOR DRAIN NEW TO EXISTING CONNECTION CLEAN OUT IN EXPOSED OR ABOVE CEILING LINE ———— INLINE PIPE UP CLEAN OUT IN FLOOR/GRADE CLEAN OUT IN STACK NOT ALL ITEMS USED

- WASTE PIPING NOTES: 1. ALL EXISTING VENT, AND SEWER PIPING IS UNKNOWN. EXISTING AS-BUILT PLANS ARE NOT AVAILABLE. PLUMBING CONTRACTOR SHALL FIELD VERIFY ALL LOCATIONS, DISTANCES, SIZES ELEVATIONS and INVERTS OF VENT, SEWER AND GREASE PIPING.
- 2. NO WORK SHALL BE STARTED BEFORE ALL PIPING LOCATIONS, SIZES and ELEVATIONS HAVE BEEN CONFIRMED.
- HIS BID WORK FOR CONFIRMING LOCATIONS, SIZES, DISTANCES and ELEVATIONS BEFORE STARTING WORK. 4. COORDINATE WITH PROJECT MANAGER FOR RESOLUTION.
- 3. PLUMBING CONTRACTOR SHALL INCLUDE IN

## NOTE: CONTRACTOR TO PATCH AND REPAIR ALL FLOORS, WALLS AND CEILINGS TO MATCH NEW FINISHES. REFER TO ARCHITECTURAL DRAWINGS.

## SEE ARCHITECTURAL PLANS FOR BUILDING LOCATIONS.

PLUMBING TRENCHING NOTE: ALL EXISTING WASTE PIPING SHOWN SHALL BE VERIFIED WITH PLUMBING INSPECTION CAMERA IN FIELD BEFORE STARTING WORK. THE EXACT LOCATIONS, SIZES AND INVERTS SHALL BE VERIFIED WITH PLUMBING INSPECTION CAMERA. PLUMBING INSPECTION CAMERA MUST BE INCLUDED IN BID PROCESS. PLUMBING INSPECTION CAMERA WORK MUST BE DONE BEFORE DIGGING, TRENCHING EXCAVATION WORK CAN BE STARTED.


**SUPPLY LINE NOTE NOTE:** 

HOUSING AUTHORITY.


PROVIDE NEW BRAIDED SUPPLY

LINES AND STOPS PROVIDED BY

LINES AND STOPS. BRAIDED SUPPLY

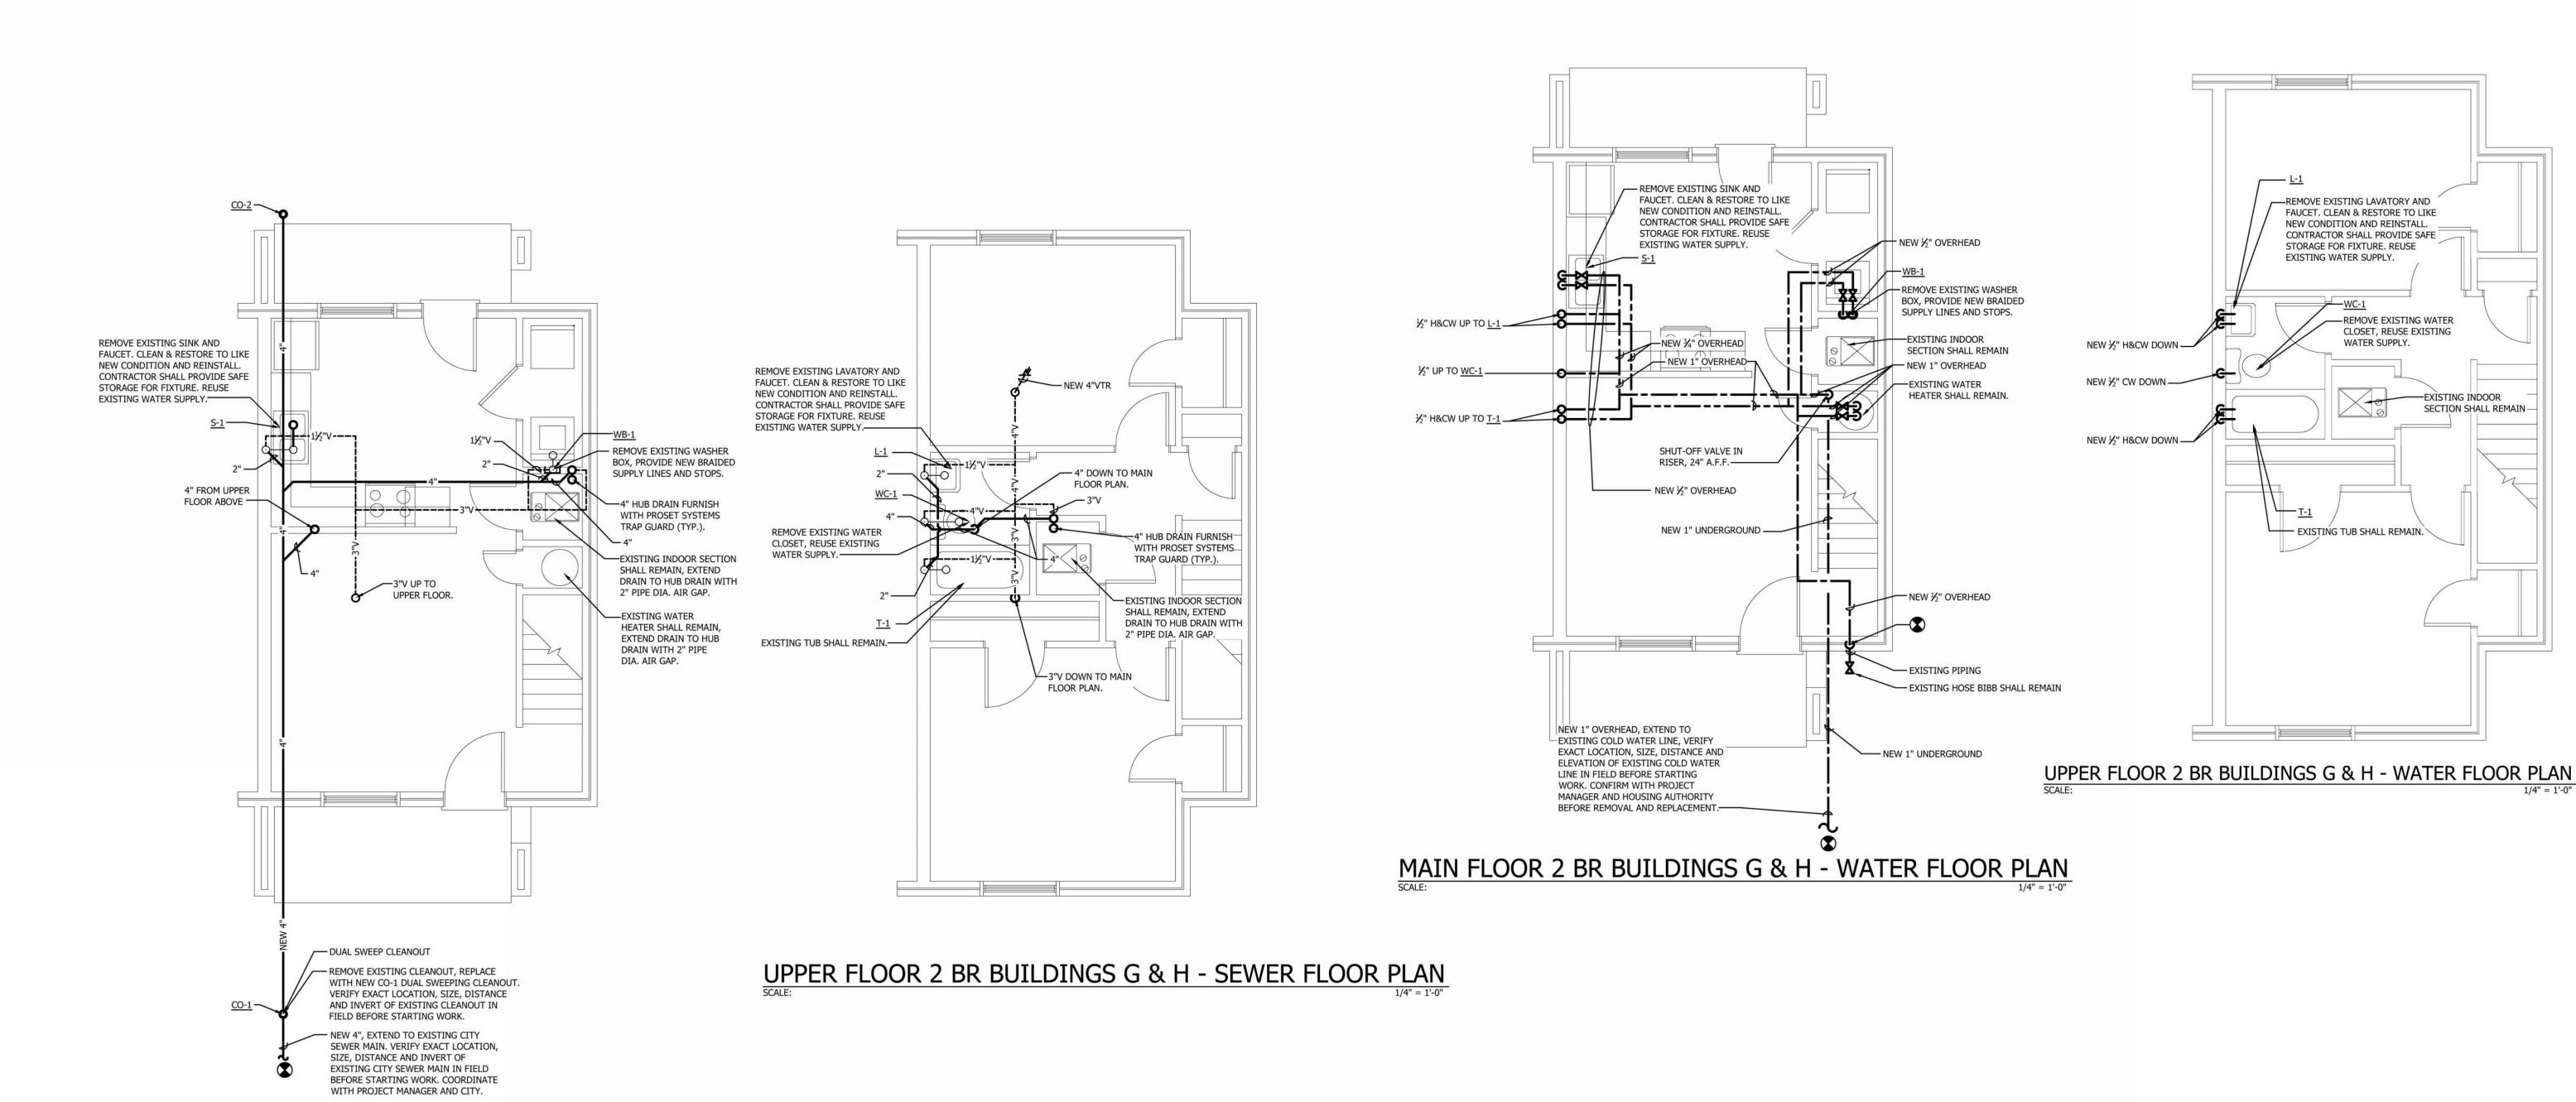

MAIN FLOOR 2 BR BUILDINGS G & H - SEWER FLOOR PLAN

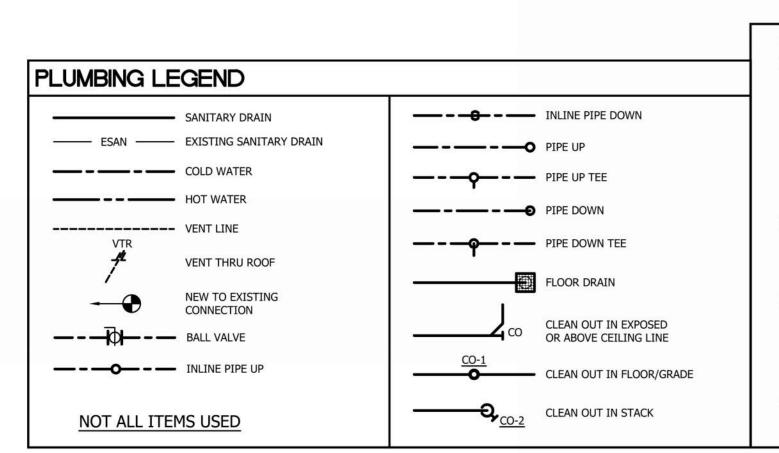

- WASTE PIPING NOTES: ALL EXISTING VENT, AND SEWER PIPING IS UNKNOWN. EXISTING AS-BUILT PLANS ARE NOT AVAILABLE. PLUMBING CONTRACTOR SHALL FIELD VERIFY ALL LOCATIONS, DISTANCES, SIZES ELEVATIONS and INVERTS OF VENT, SEWER AND GREASE PIPING.
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- 3. PLUMBING CONTRACTOR SHALL INCLUDE IN HIS BID WORK FOR CONFIRMING LOCATIONS, SIZES, DISTANCES and ELEVATIONS BEFORE STARTING WORK. 4. COORDINATE WITH PROJECT MANAGER FOR
  - RESOLUTION.

# NOTE:

CONTRACTOR TO PATCH AND REPAIR ALL FLOORS, WALLS AND CEILINGS TO MATCH NEW FINISHES. REFER TO ARCHITECTURAL DRAWINGS.

#### SEE ARCHITECTURAL PLANS FOR BUILDING LOCATIONS.

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**SUPPLY LINE NOTE NOTE:** PROVIDE NEW BRAIDED SUPPLY LINES AND STOPS. BRAIDED SUPPLY LINES AND STOPS PROVIDED BY HOUSING AUTHORITY.

## POINT OF CONNECTION POINT OF CONNECTION FOR NEW PIPING. CONNECT NEW PIPING TO EXISTING PIPING, VERIFY EXACT SIZE, LOCATION, DISTANCE & INVERT IN FIELD BEFORE STARTING WORK.

Drawing No.

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**SUPPLY LINE NOTE NOTE:** 

HOUSING AUTHORITY.

SEE ARCHITECTURAL PLANS

FOR BUILDING LOCATIONS.


PROVIDE NEW BRAIDED SUPPLY

LINES AND STOPS PROVIDED BY

POINT OF CONNECTION

POINT OF CONNECTION FOR NEW PIPING. CONNECT NEW PIPING TO EXISTING PIPING, VERIFY EXACT SIZE, LOCATION, DISTANCE & INVERT IN FIELD BEFORE STARTING WORK.


LINES AND STOPS. BRAIDED SUPPLY

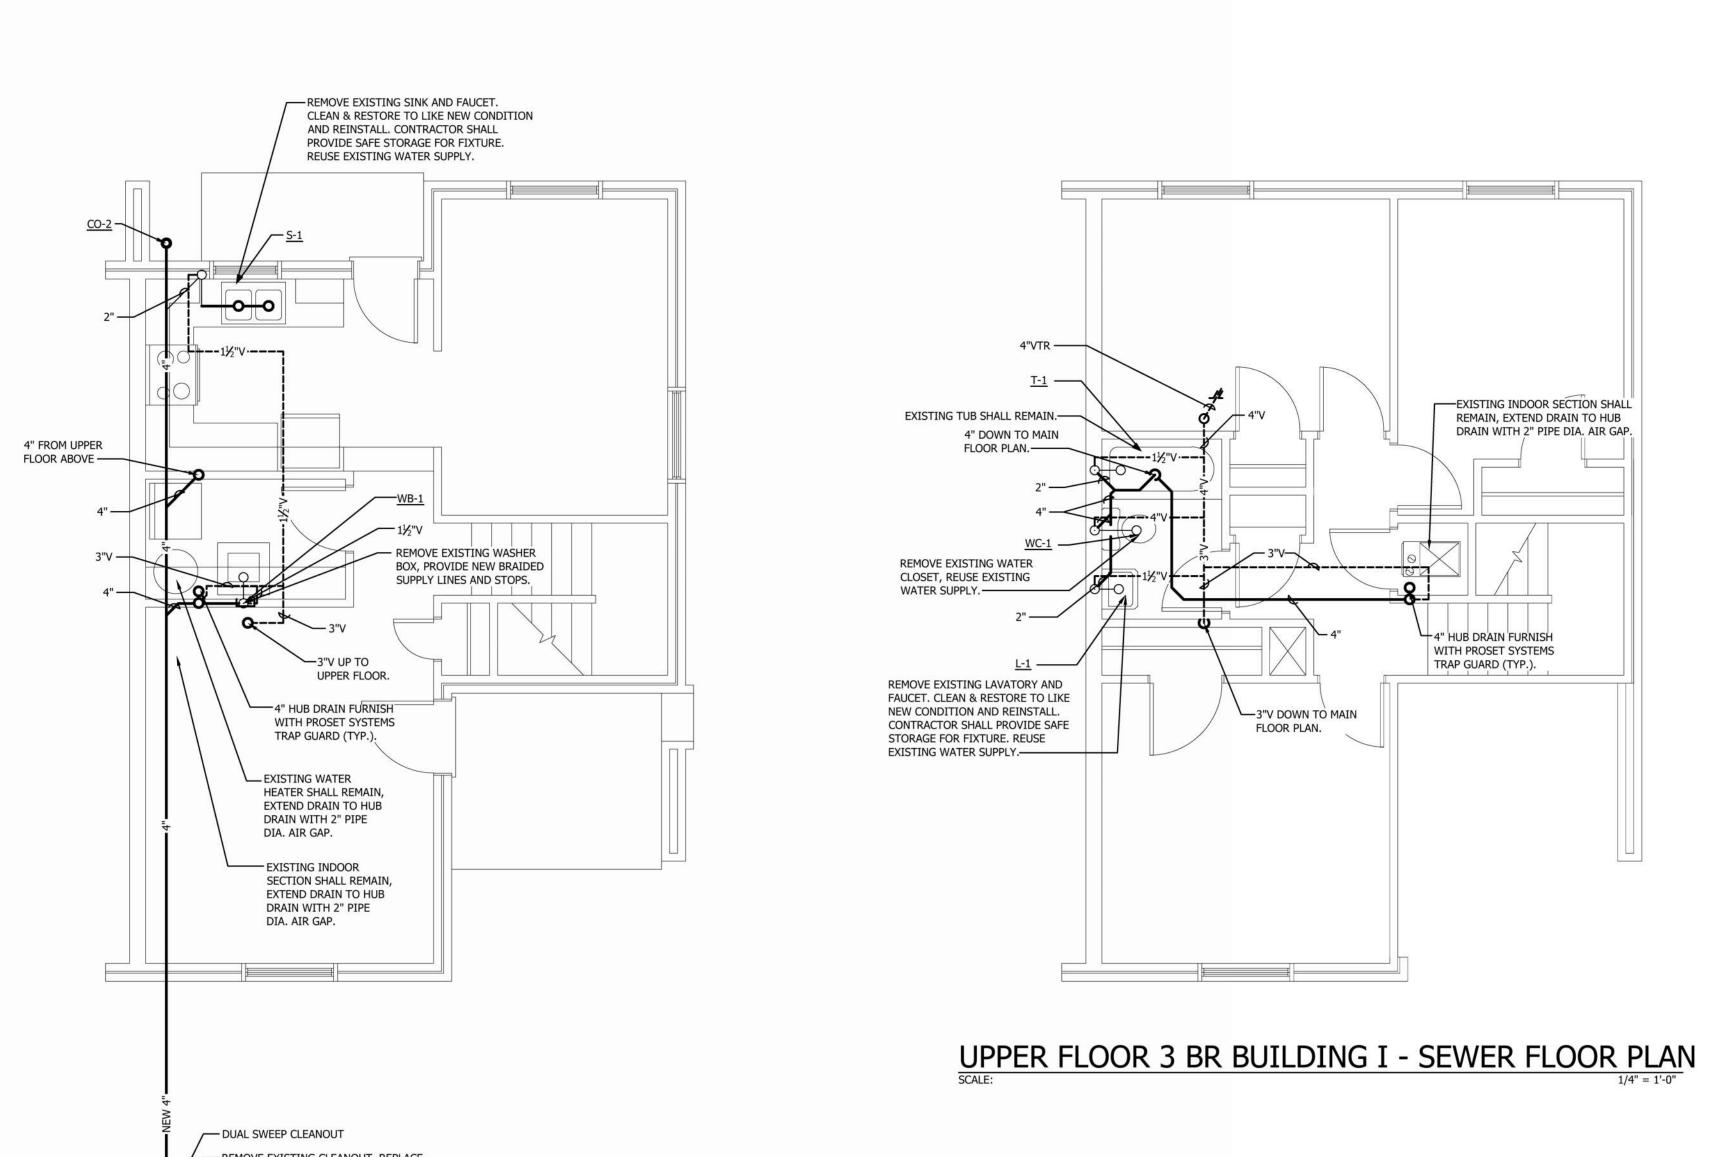

EXISTING CITY SEWER MAIN IN FIELD BEFORE STARTING WORK. COORDINATE WITH PROJECT MANAGER AND CITY. MAIN FLOOR 3 BR BUILDING I - SEWER FLOOR PLAN

WITH NEW CO-1 DUAL SWEEPING CLEANOUT VERIFY EXACT LOCATION, SIZE, DISTANCE AND INVERT OF EXISTING CLEANOUT IN FIELD BEFORE STARTING WORK.

SEWER MAIN. VERIFY EXACT LOCATION SIZE, DISTANCE AND INVERT OF

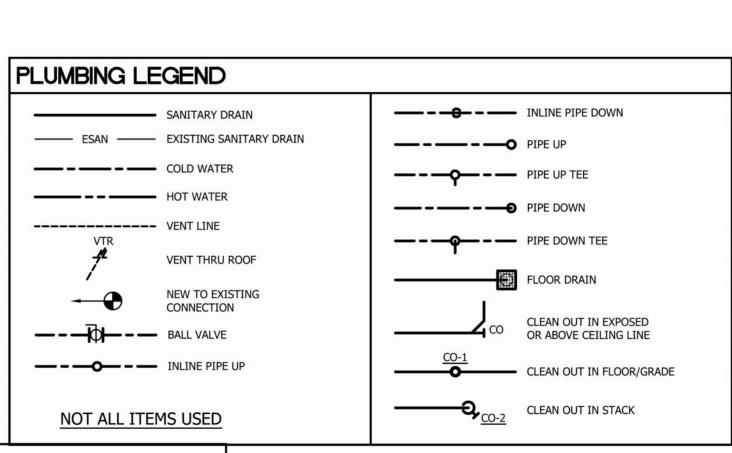

NOTE: CONTRACTOR TO PATCH AND REPAIR ALL FLOORS, WALLS AND CEILINGS TO MATCH NEW FINISHES. REFER TO


ARCHITECTURAL DRAWINGS.


PLUMBING TRENCHING NOTE: PLUMBING INSPECTION CAMERA MUST BE INCLUDED IN BID PROCESS. PLUMBING


ALL EXISTING WASTE PIPING SHOWN SHALL BE VERIFIED WITH PLUMBING INSPECTION CAMERA IN FIELD BEFORE STARTING WORK. THE EXACT LOCATIONS, SIZES AND INVERTS SHALL BE VERIFIED WITH PLUMBING INSPECTION CAMERA. INSPECTION CAMERA WORK MUST BE DONE BEFORE DIGGING, TRENCHING EXCAVATION WORK CAN BE STARTED.

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COORDINATE WITH PROJECT MANAGER FOR RESOLUTION.



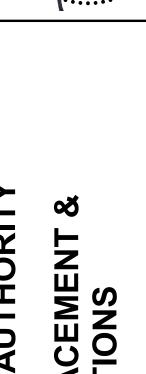

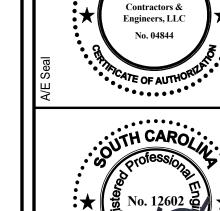

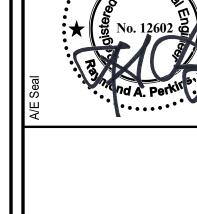

EXISTING INDOOR SECTION SHALL REMAIN,

UPPER FLOOR 3 BR BUILDING I - WATER FLOOR PLAN

#### REMOVE EXISTING SINK AND FAUCET. CLEAN & RESTORE TO LIKE NEW CONDITION AND REINSTALL. CONTRACTOR SHALL PROVIDE SAFE STORAGE FOR FIXTURE. PROVIDE NEW ABOVE FLOOR. BRAIDED SUPPLY LINES AND STOPS: NEW ½" OVERHEAD — ½" H&CW UP TO <u>T-1</u> ½" H&CW UP TO WC-1 \_ - REMOVE EXISTING WASHER BOX, PROVIDE NEW BRAIDED SUPPLY LINES AND STOPS. NEW ½" OVERHEAD — EXISTING WATER SHUT-OFF VALVE IN NEW 1" UNDERGROUND RISER, 24" A.F.F.-----NEW 1" OVERHEAD, EXTEND TO EXISTING COLD WATER LINE, VERIFY - EXISTING HOSE BIBB SHALL REMAIN EXACT LOCATION, SIZE, DISTANCE AND ELEVATION OF EXISTING COLD WATER LINE IN FIELD BEFORE STARTING WORK. CONFIRM WITH PROJECT NEW 1" UNDERGROUND MANAGER AND HOUSING AUTHORITY BEFORE REMOVAL AND REPLACEMENT.-

MAIN FLOOR 3 BR BUILDING I - WATER FLOOR PLAN

#### PLUMBING LEGEND ———— INLINE PIPE DOWN ---- ESAN ---- EXISTING SANITARY DRAIN ———— PIPE UP ———— COLD WATER ———— PIPE UP TEE ————— PIPE DOWN VENT THRU ROOF FLOOR DRAIN CLEAN OUT IN EXPOSED ——— BALL VALVE OR ABOVE CEILING LINE ———— INLINE PIPE UP NOT ALL ITEMS USED

WASTE PIPING NOTES: 1. ALL EXISTING VENT, AND SEWER PIPING IS UNKNOWN. EXISTING AS-BUILT PLANS ARE NOT AVAILABLE. PLUMBING CONTRACTOR SHALL FIELD VERIFY ALL LOCATIONS, DISTANCES, SIZES ELEVATIONS and INVERTS OF VENT, SEWER AND GREASE PIPING. NO WORK SHALL BE STARTED BEFORE ALL PIPING LOCATIONS, SIZES and ELEVATIONS HAVE BEEN CONFIRMED. 3. PLUMBING CONTRACTOR SHALL INCLUDE IN HIS BID WORK

FOR CONFIRMING LOCATIONS, SIZES, DISTANCES and

COORDINATE WITH PROJECT MANAGER FOR RESOLUTION.

ELEVATIONS BEFORE STARTING WORK.

NOTE: CONTRACTOR TO PATCH AND REPAIR ALL FLOORS, WALLS AND CEILINGS TO MATCH NEW FINISHES. REFER TO ARCHITECTURAL DRAWINGS.

PLUMBING TRENCHING NOTE: ALL EXISTING WASTE PIPING SHOWN SHALL BE VERIFIED WITH PLUMBING INSPECTION CAMERA IN FIELD BEFORE STARTING WORK. THE EXACT LOCATIONS, SIZES AND INVERTS SHALL BE VERIFIED WITH PLUMBING INSPECTION CAMERA. PLUMBING INSPECTION CAMERA MUST BE INCLUDED IN BID PROCESS. PLUMBING INSPECTION CAMERA WORK MUST BE DONE BEFORE DIGGING, TRENCHING EXCAVATION WORK CAN BE STARTED.

EXISTING TUB SHALL REMAIN.-

½" H&CW DOWN. —

REMOVE EXISTING WATER CLOSET, REUSE EXISTING

REMOVE EXISTING LAVATORY AND FAUCET. CLEAN & RESTORE TO LIKE NEW CONDITION AND REINSTALL.

CONTRACTOR SHALL PROVIDE SAFE

STORAGE FOR FIXTURE. REUSE

WATER SUPPLY. ----

NEW ½" H&CW DOWN -


光" CW DOWN ——

**SUPPLY LINE NOTE NOTE:** PROVIDE NEW BRAIDED SUPPLY LINES AND STOPS. BRAIDED SUPPLY LINES AND STOPS PROVIDED BY HOUSING AUTHORITY.

SEE ARCHITECTURAL PLANS FOR BUILDING LOCATIONS.

# POINT OF CONNECTION POINT OF CONNECTION FOR NEW PIPING. CONNECT NEW PIPING TO EXISTING PIPING, VERIFY EXACT SIZE, LOCATION, DISTANCE & INVERT IN FIELD BEFORE STARTING WORK.




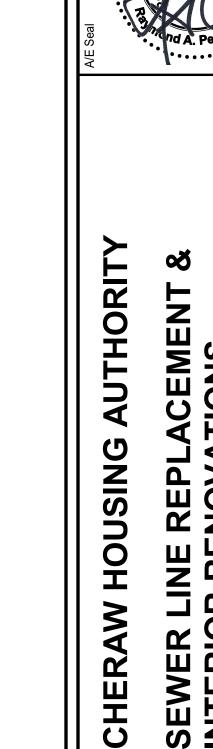

4" FROM UPPER FLOOR ABOVE EXISTING TUB SHALL REMAIN.— EXISTING INDOOR SECTION SHALL - EXISTING WATER REMOVE EXISTING WASHER REMAIN, EXTEND DRAIN TO HUB HEATER SHALL REMAIN, BOX, PROVIDE NEW BRAIDED DRAIN WITH 2" PIPE DIA. AIR GAP. EXTEND DRAIN TO HUB -REMOVE EXISTING SINK AND SUPPLY LINES AND STOPS. — FAUCET. CLEAN & RESTORE TO LIKE DRAIN WITH 2" PIPE DIA. AIR GAP. NEW CONDITION AND REINSTALL. CONTRACTOR SHALL PROVIDE SAFE —4" HUB DRAIN FURNISH -4" HUB DRAIN FURNISH STORAGE FOR FIXTURE. REUSE WITH PROSET SYSTEMS WITH PROSET SYSTEMS EXISTING WATER SUPPLY. 4" DOWN TO MAIN REMOVE EXISTING WATER TRAP GUARD (TYP.). TRAP GUARD (TYP.). CLOSET, REUSE EXISTING WATER SUPPLY. ----REMOVE EXISTING WATER CLOSET, REUSE EXISTING REMOVE EXISTING LAVATORY AND WATER SUPPLY. ---FAUCET. CLEAN & RESTORE TO LIKE NEW CONDITION AND REINSTALL. CONTRACTOR SHALL PROVIDE SAFE STORAGE FOR FIXTURE. REUSE EXISTING WATER SUPPLY.—— FAUCET. CLEAN & RESTORE TO LIKE NEW CONDITION AND REINSTALL. CONTRACTOR SHALL PROVIDE SAFE STORAGE FOR FIXTURE. REUSE EXISTING WATER SUPPLY.——— ─3"V DOWN TO MAIN V3"V UP TO FLOOR PLAN. UPPER FLOOR. - REMOVE EXISTING CLEANOUT, REPLACE WITH NEW CO-1 DUAL SWEEPING CLEANOUT. VERIFY EXACT LOCATION, SIZE, DISTANCE UPPER FLOOR 4 BR BUILDING J - SEWER FLOOR PLAN AND INVERT OF EXISTING CLEANOUT IN FIELD BEFORE STARTING WORK.

WITH PROJECT MANAGER AND CITY. MAIN FLOOR 4 BR BUILDING J - SEWER FLOOR PLAN
SCALE: 1/4" = 1'-0"

SIZE, DISTANCE AND INVERT OF EXISTING CITY SEWER MAIN IN FIELD BEFORE STARTING WORK. COORDINATE

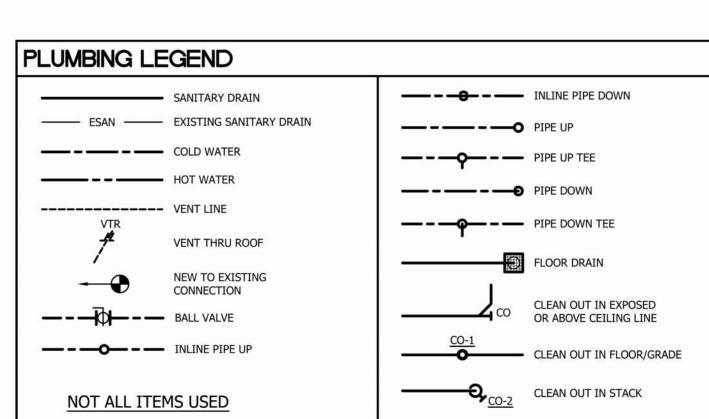

WASTE PIPING NOTES: 1. ALL EXISTING VENT, AND SEWER PIPING IS UNKNOWN. EXISTING AS-BUILT PLANS ARE NOT AVAILABLE. PLUMBING CONTRACTOR SHALL FIELD VERIFY ALL LOCATIONS, DISTANCES, SIZES ELEVATIONS and INVERTS OF VENT, SEWER AND GREASE PIPING. NO WORK SHALL BE STARTED BEFORE ALL PIPING LOCATIONS,

SIZES and ELEVATIONS HAVE BEEN CONFIRMED. 3. PLUMBING CONTRACTOR SHALL INCLUDE IN HIS BID WORK

FOR CONFIRMING LOCATIONS, SIZES, DISTANCES and ELEVATIONS BEFORE STARTING WORK. COORDINATE WITH PROJECT MANAGER FOR RESOLUTION.

NOTE: CONTRACTOR TO PATCH AND REPAIR ALL FLOORS, WALLS AND CEILINGS TO MATCH NEW FINISHES. REFER TO ARCHITECTURAL DRAWINGS.

PLUMBING TRENCHING NOTE: ALL EXISTING WASTE PIPING SHOWN SHALL BE VERIFIED WITH PLUMBING INSPECTION CAMERA IN FIELD BEFORE STARTING WORK. THE EXACT LOCATIONS, SIZES AND INVERTS SHALL BE VERIFIED WITH PLUMBING INSPECTION CAMERA. PLUMBING INSPECTION CAMERA MUST BE INCLUDED IN BID PROCESS. PLUMBING INSPECTION CAMERA WORK MUST BE DONE BEFORE DIGGING, TRENCHING EXCAVATION WORK CAN BE STARTED.

POINT OF CONNECTION POINT OF CONNECTION FOR NEW PIPING. CONNECT NEW PIPING TO EXISTING PIPING, VERIFY EXACT SIZE, LOCATION, DISTANCE & INVERT IN FIELD BEFORE STARTING WORK.

SEE ARCHITECTURAL PLANS

FOR BUILDING LOCATIONS.

SUPPLY LINE NOTE NOTE:

HOUSING AUTHORITY.


PROVIDE NEW BRAIDED SUPPLY

LINES AND STOPS PROVIDED BY

LINES AND STOPS. BRAIDED SUPPLY

CHERAW


Drawing No. **P6** 

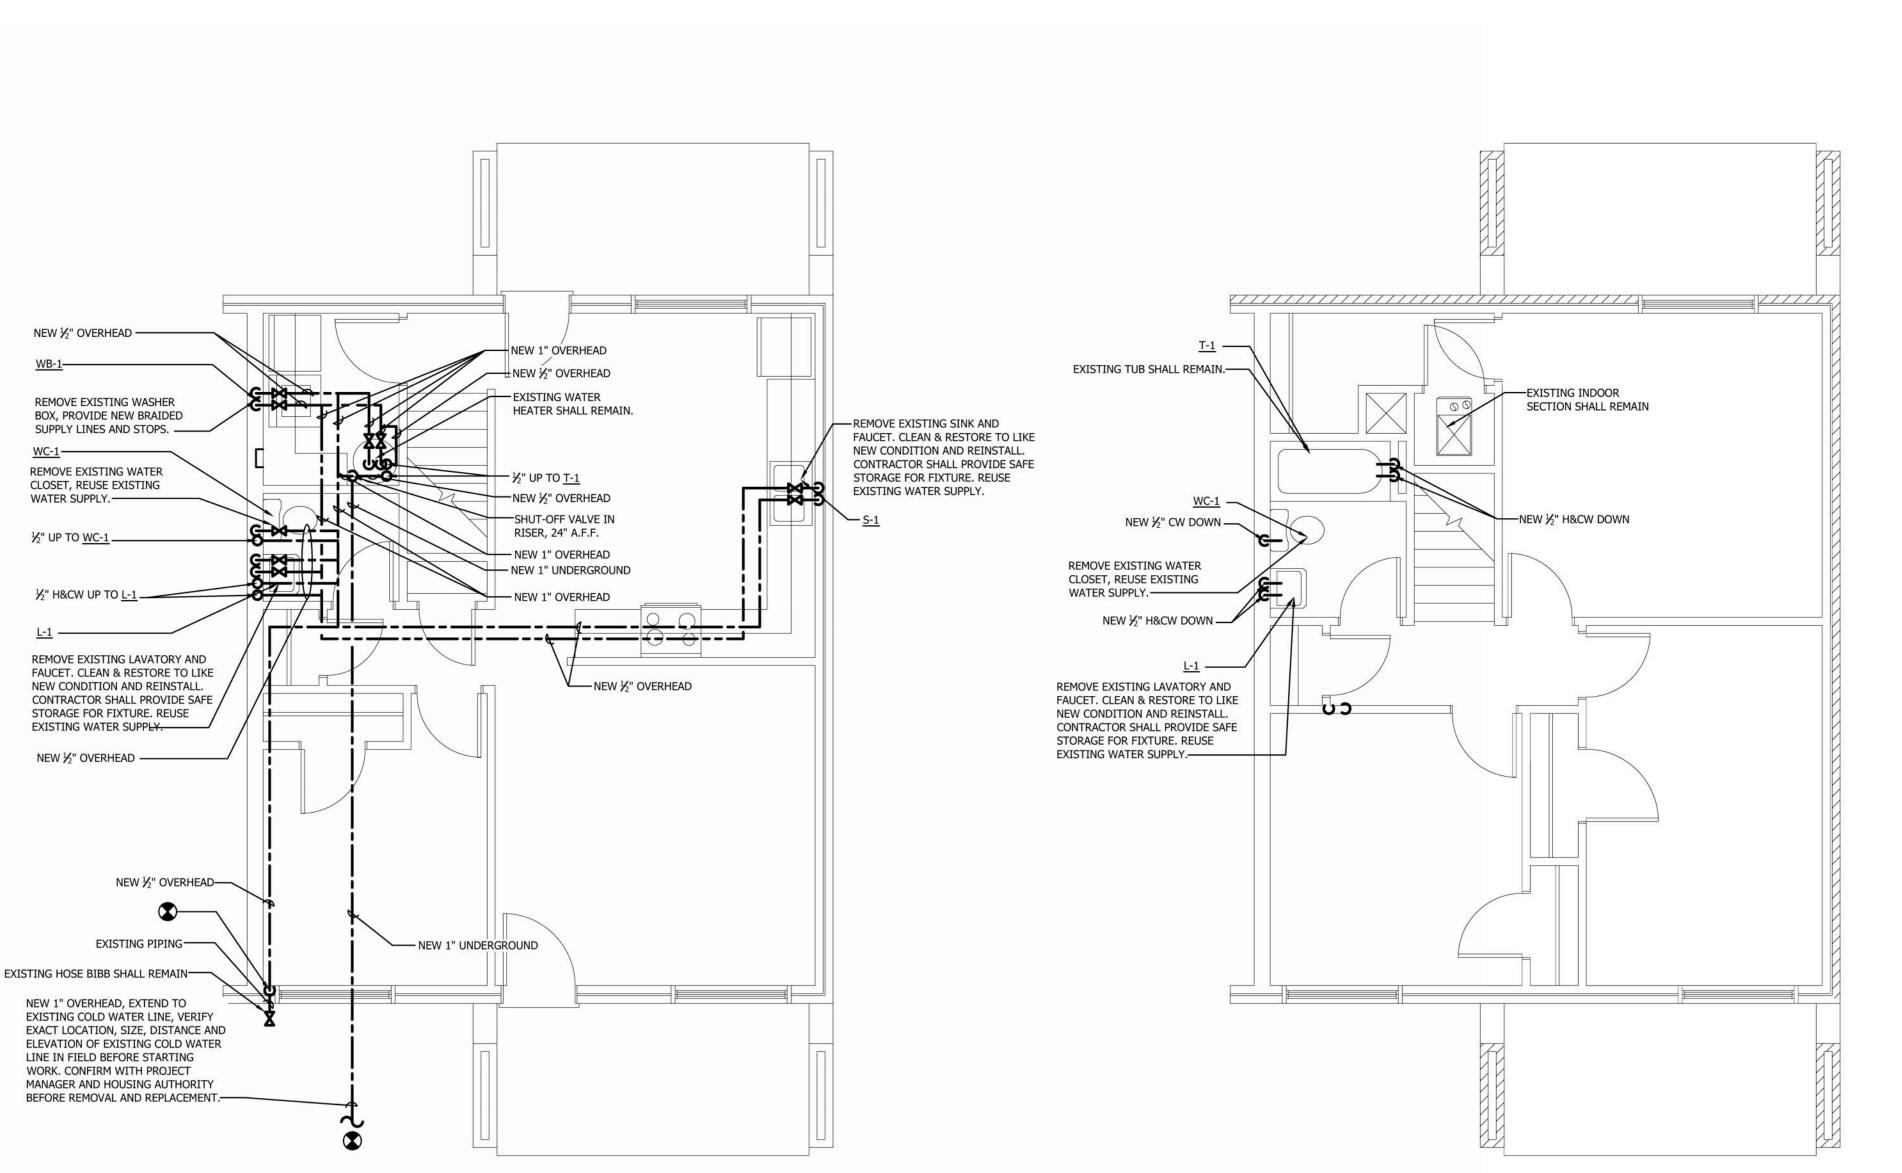

MAIN FLOOR 4 BR BUILDING J - WATER FLOOR PLAN

SCALE: 1/4" = 1'-0"

UPPER FLOOR 4 BR BUILDING J - WATER FLOOR PLAN

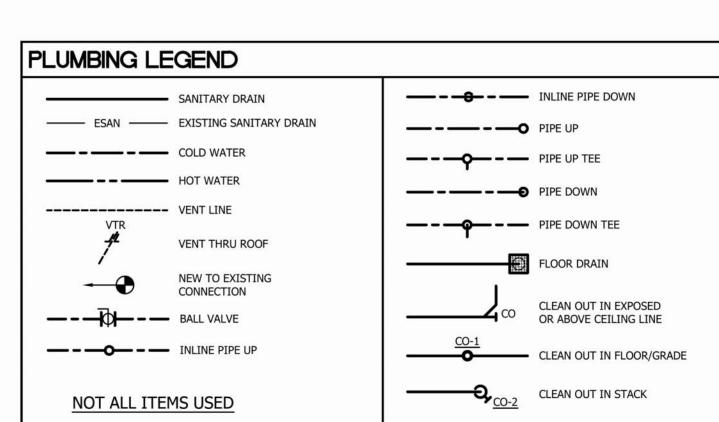

WASTE PIPING NOTES: 1. ALL EXISTING VENT, AND SEWER PIPING IS UNKNOWN. EXISTING AS-BUILT PLANS ARE NOT AVAILABLE. PLUMBING CONTRACTOR SHALL FIELD VERIFY ALL LOCATIONS, DISTANCES, SIZES ELEVATIONS and INVERTS OF VENT, SEWER

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NOTE: CONTRACTOR TO PATCH AND REPAIR ALL FLOORS, WALLS AND CEILINGS TO MATCH NEW FINISHES. REFER TO ARCHITECTURAL DRAWINGS.

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HOUSING AUTHORITY. SEE ARCHITECTURAL PLANS

SUPPLY LINE NOTE NOTE:

PROVIDE NEW BRAIDED SUPPLY

LINES AND STOPS PROVIDED BY

LINES AND STOPS. BRAIDED SUPPLY

FOR BUILDING LOCATIONS.

POINT OF CONNECTION POINT OF CONNECTION FOR NEW PIPING. CONNECT NEW PIPING TO EXISTING PIPING, VERIFY EXACT SIZE, LOCATION, DISTANCE & INVERT IN FIELD BEFORE STARTING WORK.

BUILDII LAN ъ П Drawing No.

POINT OF CONNECTION POINT OF CONNECTION FOR NEW PIPING. CONNECT NEW PIPING TO EXISTING PIPING, VERIFY EXACT SIZE, LOCATION, DISTANCE & INVERT IN FIELD BEFORE STARTING WORK.

SUPPLY LINE NOTE NOTE:

HOUSING AUTHORITY.

SEE ARCHITECTURAL PLANS


FOR BUILDING LOCATIONS.

PROVIDE NEW BRAIDED SUPPLY


LINES AND STOPS PROVIDED BY

LINES AND STOPS. BRAIDED SUPPLY



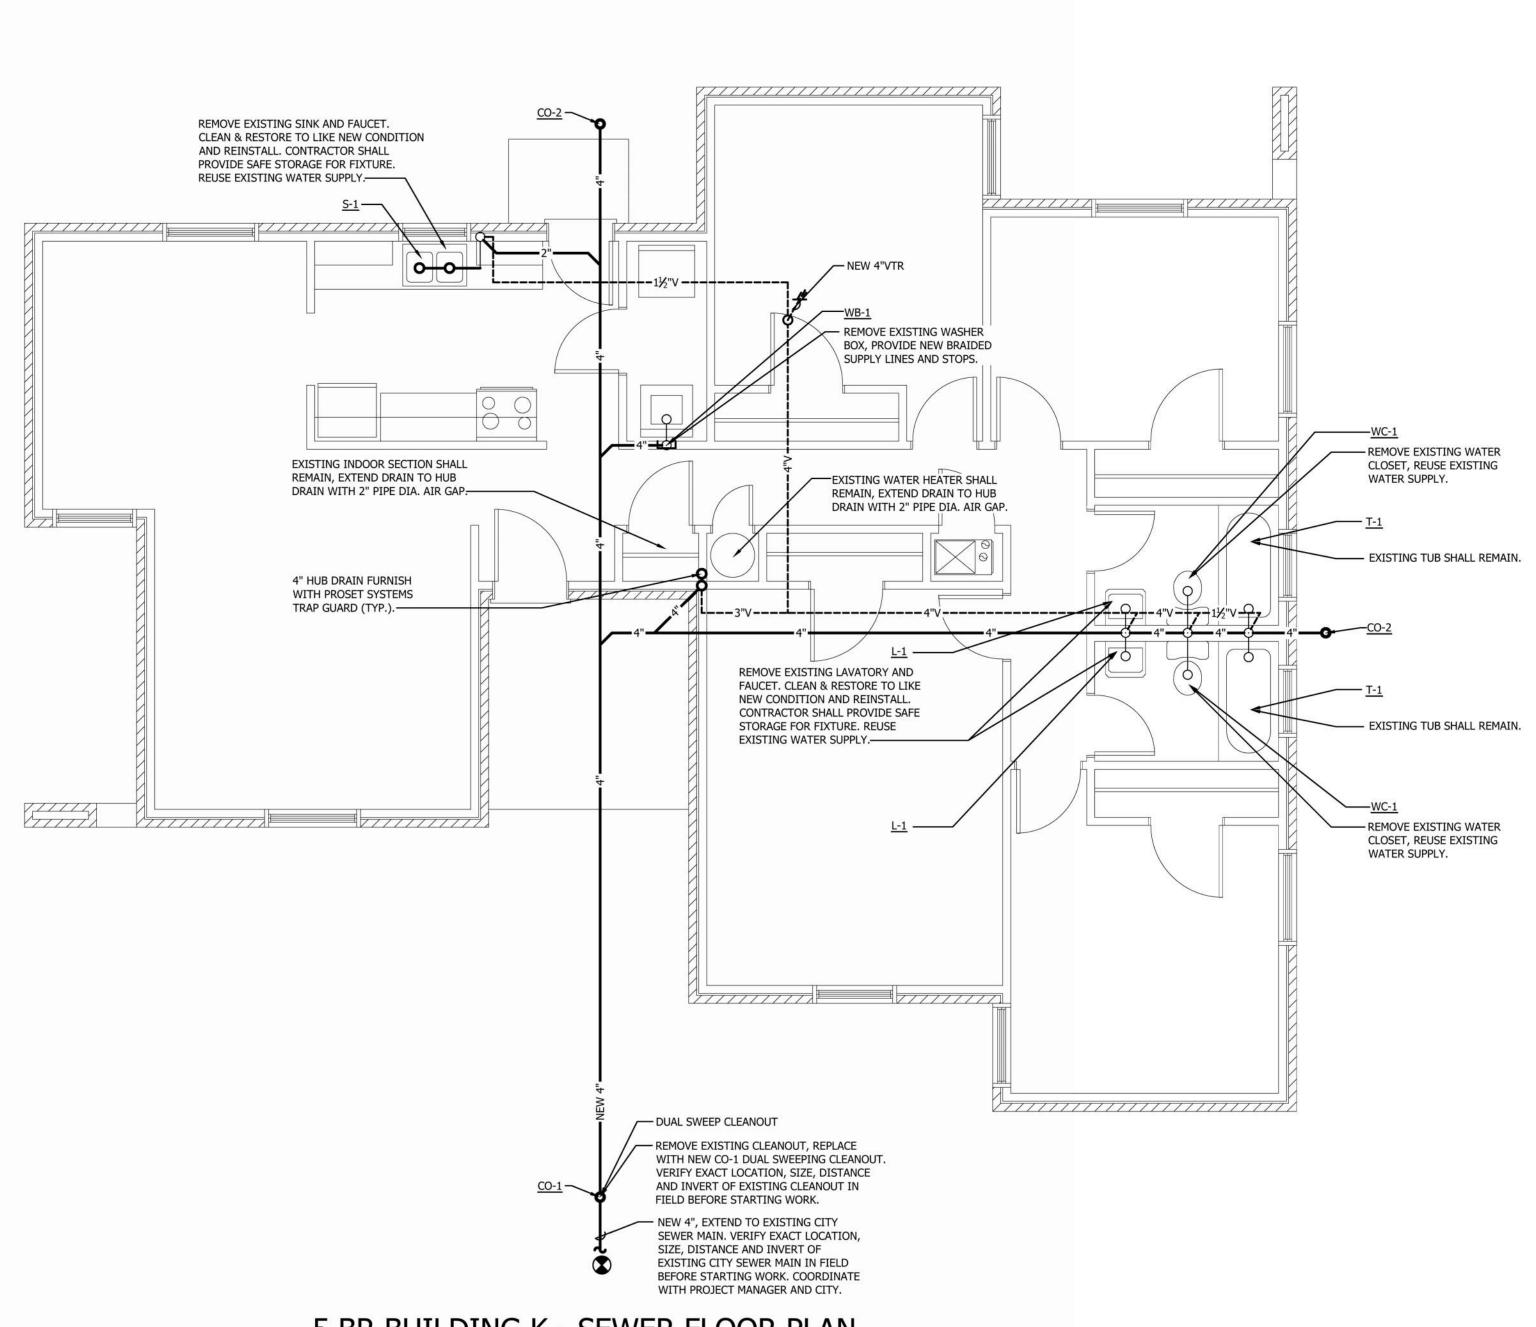

5 BR BUILDING K - SEWER FLOOR PLAN

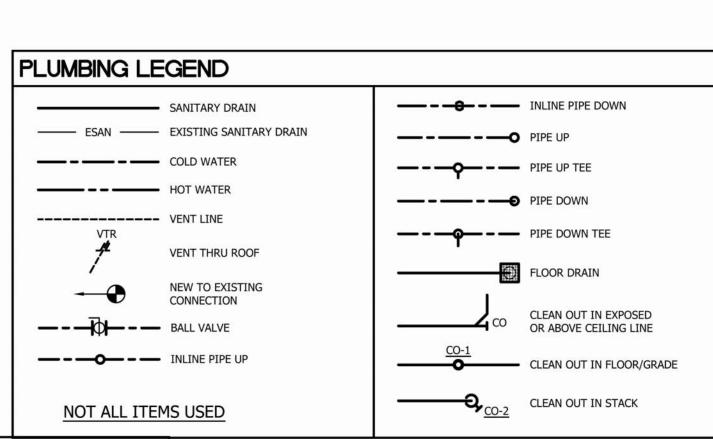

NOTE: CONTRACTOR TO PATCH AND REPAIR ALL FLOORS, WALLS AND CEILINGS TO MATCH NEW FINISHES. REFER TO ARCHITECTURAL DRAWINGS.

PLUMBING TRENCHING NOTE: ALL EXISTING WASTE PIPING SHOWN SHALL BE VERIFIED WITH PLUMBING INSPECTION CAMERA IN FIELD BEFORE STARTING WORK. THE EXACT LOCATIONS, SIZES AND INVERTS SHALL BE VERIFIED WITH PLUMBING INSPECTION CAMERA. PLUMBING INSPECTION CAMERA MUST BE INCLUDED IN BID PROCESS. PLUMBING INSPECTION CAMERA WORK MUST BE DONE BEFORE DIGGING, TRENCHING EXCAVATION WORK CAN BE STARTED.

- WASTE PIPING NOTES: 1. ALL EXISTING VENT, AND SEWER PIPING IS UNKNOWN. EXISTING AS-BUILT PLANS ARE NOT AVAILABLE. PLUMBING CONTRACTOR SHALL FIELD VERIFY ALL LOCATIONS, DISTANCES, SIZES ELEVATIONS and INVERTS OF VENT, SEWER AND GREASE PIPING.
- NO WORK SHALL BE STARTED BEFORE ALL PIPING LOCATIONS,
- SIZES and ELEVATIONS HAVE BEEN CONFIRMED. 3. PLUMBING CONTRACTOR SHALL INCLUDE IN HIS BID WORK FOR CONFIRMING LOCATIONS, SIZES, DISTANCES and
- ELEVATIONS BEFORE STARTING WORK. COORDINATE WITH PROJECT MANAGER FOR RESOLUTION.

SUPPLY LINE NOTE NOTE:

HOUSING AUTHORITY.

SEE ARCHITECTURAL PLANS

FOR BUILDING LOCATIONS.

POINT OF CONNECTION

POINT OF CONNECTION FOR NEW PIPING. CONNECT NEW PIPING TO EXISTING PIPING, VERIFY EXACT SIZE, LOCATION, DISTANCE & INVERT IN FIELD BEFORE STARTING WORK.


PROVIDE NEW BRAIDED SUPPLY

LINES AND STOPS PROVIDED BY


LINES AND STOPS. BRAIDED SUPPLY

BUILDII LAN

ъ П Drawing No.

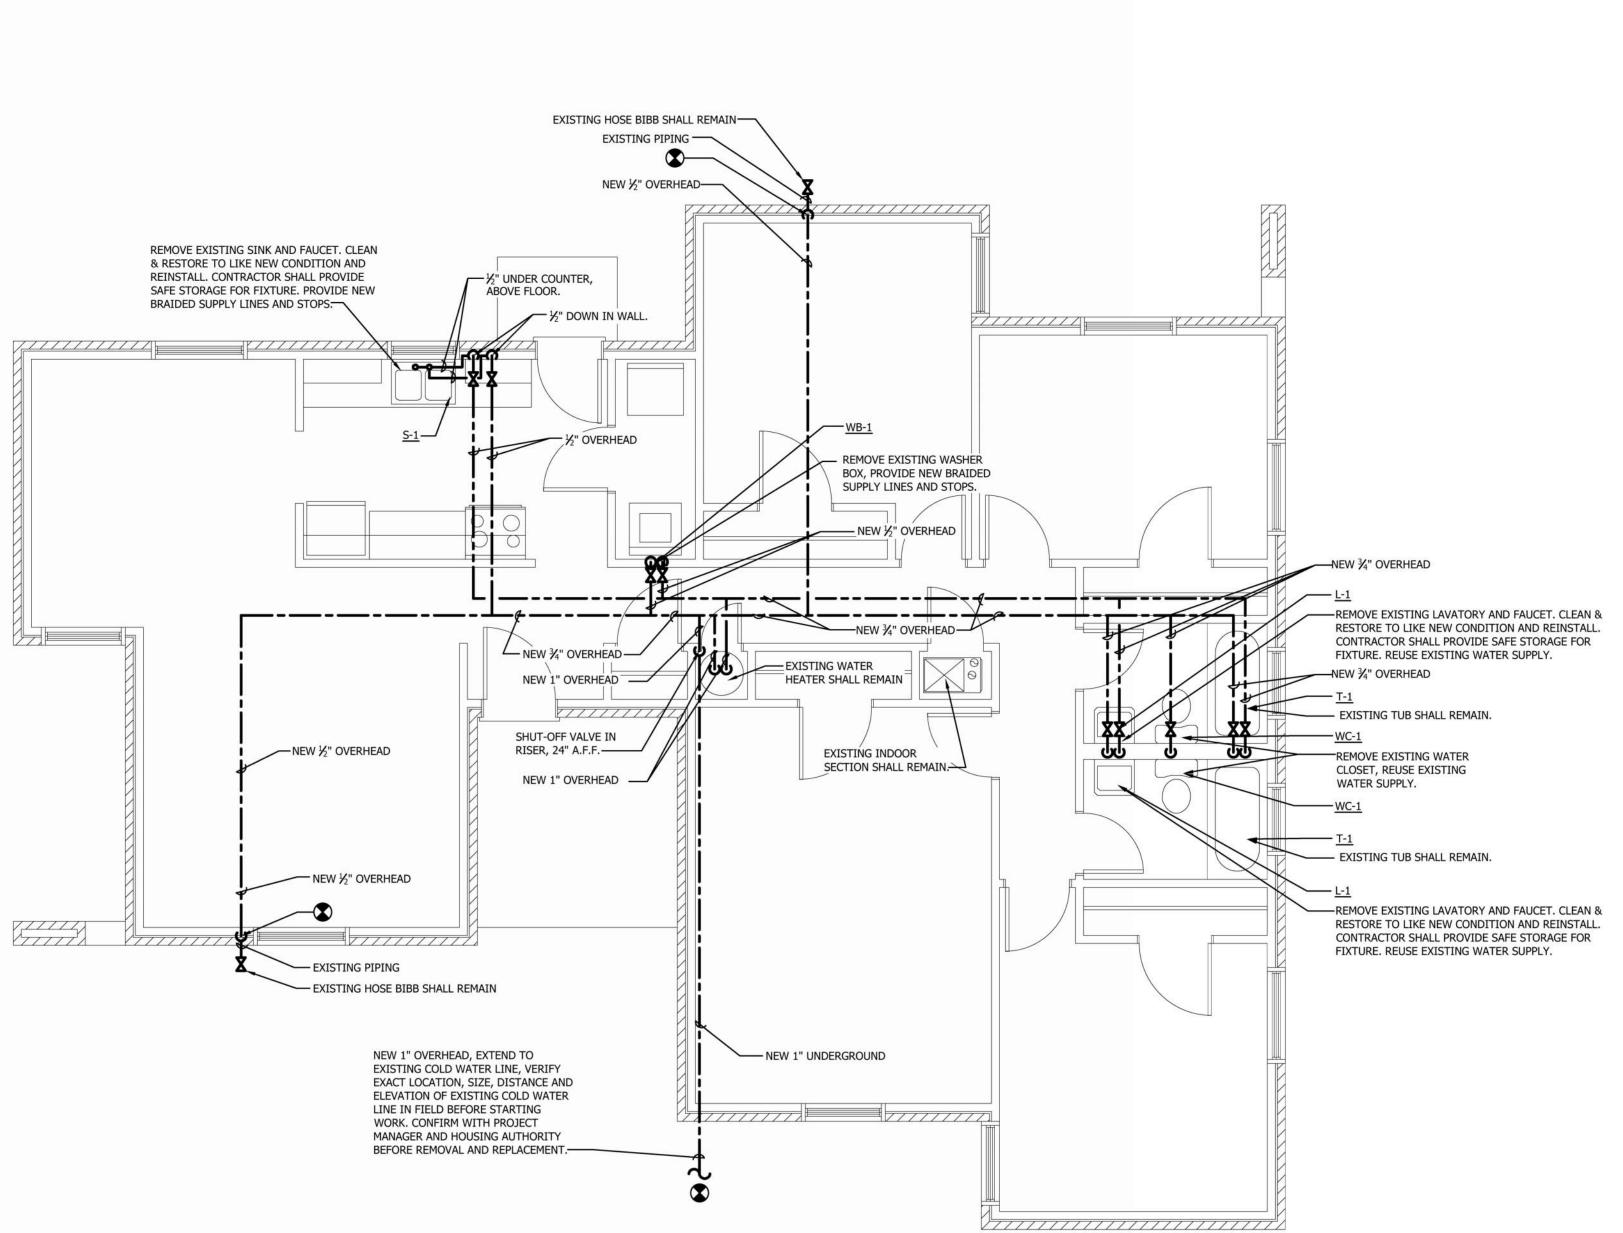

5 BR BUILDING K - WATER FLOOR PLAN

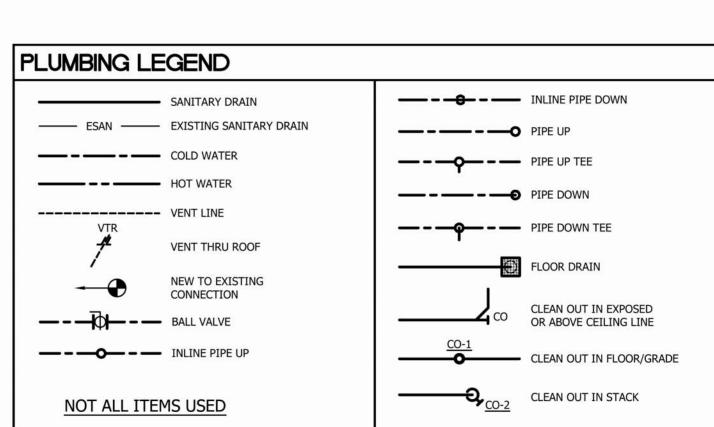

PLUMBING TRENCHING NOTE: ALL EXISTING WASTE PIPING SHOWN SHALL BE VERIFIED WITH PLUMBING INSPECTION CAMERA IN FIELD BEFORE STARTING WORK. THE EXACT LOCATIONS, SIZES AND INVERTS SHALL BE VERIFIED WITH PLUMBING INSPECTION CAMERA. PLUMBING INSPECTION CAMERA MUST BE INCLUDED IN BID PROCESS. PLUMBING INSPECTION CAMERA WORK MUST BE DONE BEFORE DIGGING, TRENCHING EXCAVATION WORK CAN BE STARTED.

NOTE: CONTRACTOR TO PATCH AND REPAIR ALL FLOORS, WALLS AND CEILINGS TO MATCH NEW FINISHES. REFER TO ARCHITECTURAL DRAWINGS.

WASTE PIPING NOTES:

AND GREASE PIPING.

1. ALL EXISTING VENT, AND SEWER PIPING IS UNKNOWN.

CONTRACTOR SHALL FIELD VERIFY ALL LOCATIONS,

SIZES and ELEVATIONS HAVE BEEN CONFIRMED.

ELEVATIONS BEFORE STARTING WORK.

3. PLUMBING CONTRACTOR SHALL INCLUDE IN HIS BID WORK


FOR CONFIRMING LOCATIONS, SIZES, DISTANCES and

COORDINATE WITH PROJECT MANAGER FOR RESOLUTION.

EXISTING AS-BUILT PLANS ARE NOT AVAILABLE. PLUMBING

DISTANCES, SIZES ELEVATIONS and INVERTS OF VENT, SEWER

NO WORK SHALL BE STARTED BEFORE ALL PIPING LOCATIONS,

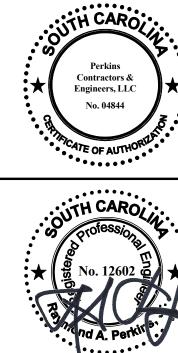

# SING 9 里

**DRIT** 

Description

FURNISHED BY HOUSING AUTHORITY, COORDINATE WITH HOUSING AUTHORITY FOR INSTALLATION.

FURNISHED BY HOUSING AUTHORITY, COORDINATE WITH HOUSING AUTHORITY FOR INSTALLATION.

TYPE "L" ABOVE GRADE

\*\* PEX COLOR CODED

ELASTOMERIC

TYPE "M" IS NOT ACCEPTABLE

SUBMIT COPPER PIPING FOR

LINES WITH 1/2" THICK SELF-SEAL

#### GENERAL PLUMBING NOTES:

- THE DRAWINGS ARE GENERALLY DIAGRAMMATIC AND INDICATE THE APPROXIMATE ROUTING OF PIPING AND LOCATION OF FIXTURES. THE CONTRACTOR SHALL COORDINATE HIS WORK WITH OTHER TRADES AND MAKE MINOR OFFSETS AND ADJUSTMENTS AS REQUIRED AT NO ADDITIONAL COST TO THE OWNER.
- 2. COORDINATE FIXTURE LOCATIONS WITH ARCHITECTURAL DRAWINGS.
- 3. CONTRACTOR SHALL MAKE ARRANGEMENTS FOR CONNECTIONS TO ALL UTILITY LINES AND PAY FEES AND COSTS FOR CONNECTIONS TO THOSE SERVICES.
- 4. ALL PIPING SHALL BE RUN IN CONCEALED LOCATIONS EXCEPT WHERE NOTED. . PLUMBING FIXTURES SHALL BE FIRST QUALITY VITREOUS CHINA, STAINLESS STEEL, OR PLASTIC AS NOTED ON PLUMBING
- 6. REFER TO ARCHITECTURAL DRAWINGS FOR FINISHED GRADES. . DOMESTIC WATER LINES 1/2" THROUGH 2-1/2" SHALL BE TYPE "L" COPPER WITH SOLDER JOINTS, SOLDER SHALL NOT CONTAIN

FIXTURE SCHEDULE. ALL FIXTURES SHALL BE RIGIDLY CONNECTED TO THE BUILDING AND SHALL BE CLEANED AND FUNCTIONAL.

- LEAD. WATER SERVICE LINE OUTSIDE THE BUILDING MAY BE COPPER. 8. AT THE CONTRACTOR'S OPTION PEX PIPING MAY BE USED AS FOLLOWS: PEX PIPING SHALL BE EXTRUDED CROSS-LINKED POLYETHYLENE WITH MULTI-LAYER CONSTRUCTION OR EQUAL. THE PIPE SHALL MEET MINIMUM REQUIREMENTS AS DEFINED BY ASTM F876 AND F877 STANDARDS FOR HOT AND COLD WATER DISTRIBUTION. PIPE SHALL BE PRESSURE RATED IN ACCORDANCE WITH ASTM D2837 STANDARDS AND SHALL CARRY A PRESSURE RATING OF 100 PSI AT 180° F. INSERT TYPE FITTINGS SHALL MEET ASTM F1807 STANDARD FOR METAL FITTINGS, OR ASTM F2159 STANDARD FOR PLASTIC FITTINGS. ALL FITTINGS SHALL BE COMPATIBLE WITH PIPE MANUFACTURER. COPPER PIPING SHALL BE INSTALLED WITHIN 18" OF WATER HEATING DEVICES AND THEN TRANSITION TO PEX.
- EXPOSED PIPING BELOW FIXTURES SHALL BE CHROME PLATED. PIPING AT FIXTURES IN HANDICAPPED ACCESSIBLE AREAS SHALL BE INSULATED TO PROTECT AGAINST BURNS. DRAIN WASTE AND VENT PIPING SHALL BE SCHEDULE 40 PVC OR AS NOTED ON THE
- 10. ALL BURIED PIPING SHALL BE BEDDED AND COVERED IN MANUFACTURED SAND.
- 11. POTABLE WATER LINES SHALL BE INSULATED WITH 1" FLEXIBLE ELASTOMERIC PLASTIC OR FIBERGLASS PIPE INSULATION. 12. AFTER COMPLETION OF PIPING, TEST POTABLE WATER PIPING TO A PRESSURE OF 125 LBS. PER SQ. INCH AND HOLD FOR 24
- 13. TEST DRAIN WASTE AND VENT PIPING BY FILLING TO LEVEL OF HIGHEST VENT.
- 14. AFTER INSTALLATION OF POTABLE WATER PIPING, STERILIZE LINES IN ACCORDANCE WITH CODES AND HEALTH DEPARTMENT REGULATIONS AND FLUSH AND FILL WITH CLEAN WATER.
- 15. PITCH POTABLE WATER LINES TOWARD DRAINS, INSTALL DRAIN WASTE AND VENT PIPING WITH MINIMUM SLOPES OF 1/4" PER FOOT FOR LINES UP TO 2-1/2" AND 1/8" PER FOOT FOR LINES 3" AND LARGER.
- 16. REFER TO ARCHITECTURAL DRAWINGS FOR LOCATIONS AND RATINGS OF FIRE WALLS AND FLOOR CEILING ASSEMBLIES.
- 17. INSTALL FIRE STOP MATERIAL IN ACCORD WITH U.L. LISTING AT ALL PENETRATIONS. 18. SECTIONAL VALVES SHALL BE INSTALLED ON EACH BRANCH AND RISER, CLOSE TO MAIN, WHERE BRANCH OR RISER SERVES 2 OR MORE PLUMBING FIXTURES OR EQUIPMENT CONNECTIONS AND ELSEWHERE AS INDICATED. 19. IT IS THE INTENT OF THIS PROJECT TO CONFORM WITH THE REQUIREMENTS OF THE 2014 LEAD FREE ACT. EVERY EFFORT HAS
- PLUMBING CONTRACTOR TO INSTALL PRODUCTS THAT COMPLY WITH THE 2014 LEAD FREE SAFE WATER DRINKING ACT.
- 20. PROVIDE WATERTIGHT PIPE SLEEVE AND CAULKING FOR ALL PIPING PASSING THRU WALLS, FLOORS, & ROOF.

BEEN MADE TO CALL FOR PLUMBING DEVICES THAT COMPLY WITH THE ACT. EVEN SO, IT SHALL BE THE RESPONSIBILITY OF THE

- 21. THIS CONTRACTOR SHALL PROVIDE ALL CUTTING, PATCHING AND RESTORING TO LIKE NEW ALL EXISTING WALLS, FLOORS AND
- 22. THIS CONTRACTOR SCHOLL VISIT JOB SITE FOR VISUAL INSPECTION BEFORE BID DATE. 23. ALL EXISTING EQUIPMENT NOT REUSED WILL REMAIN THE PROPERTY OF THE OWNER AND BE DISPOSED OF AS DIRECTED.
- 24. PLUMBING CONTRACTOR SHALL REMOVE ALL DEBRIS CREATED BY HIS WORK. THE JOB SITE SHALL BE LEFT CLEAN AND ALL REUSED OR NEW EQUIPMENT SHALL BE LEFT IN FIRST CLASS WORKING CONDITION. 25. GUARANTEE: MECHANICAL WORK SHALL BE GUARANTEED AGAINST DEFECTS, WORKMANSHIP AND MATERIALS FOR A PERIOD OF ONE (1) YEAR AFTER DATE OF SUBSTANTIAL COMPLETION. ALL EQUIPMENT SHALL BE TURNED OVER TO THE OWNER IN

#### LUBRICATED CONDITION.

- 26. OBTAIN ALL PERMITS & PAY ALL FEES IN CONNECTION WITH THIS WORK. 27. SPACING OF PIPE HANGERS SHALL BE IN ACCORDANCE WITH ASA-B31.1. PIPING SHALL BE INSTALLED SO THAT EQUIPMENT DOES
- 29. EXISTING WATER, SEWER, VENT and GAS LINES FOR EXISTING EQUIPMENT NOT BEING REUSED SHALL BE CAPPED OFF ABOVE CEILING OR BELOW SLAB.
- 30. EXISTING DRAINS THAT ARE TO BE ABANDONED SHALL BE FILLED IN WITH CONCRETE FLUSH WITH SURROUNDING FLOOR.

#### NOT TAKE THE LOAD OF ANY PIPING. 28. PLUMBING WORK SHOWN ON THIS PLAN SHALL BE CONSIDERED NEW, UNLESS NOTED OTHERWISE.

### 31. REMOVE or ABANDON AS FIELD CONDITIONS WARRANT EXISTING PLUMBING WORK NOT SHOWN.

#### PLUMBING SPECIFICATION

- A. Scope: Furnish all labor, materials and equipment necessary for the installation of all plumbing work required on the drawings and as specified herein. B. Work Required: In general, the work consists of, but is not limited to, the following:
- Domestic Water System connecting to existing . Sanitary Sewer System connecting to existing Hot Water Piping System Plumbing Fixtures
- . Permits, Ordinances, and Inspections: 1. Obtain and pay for all permits and inspection fees required. Deliver to architect, certificates of inspections issued by the authorities.
- 2. All work shall be done in accordance with all applicable City, County, State, or National Ordinances and Codes. Effort has been made to meet or exceed requirements. The Contractor shall make any minor adjustments to meet these requirements at no additional cost to the Owner. Instructions and Instruction Booklets: The Contractor shall instruct the Owner's representative in the proper operation of all equipment. Furnish literature provided by the manufacturer. Printed instructions and maintenance data shall be bound with cover in duplicate and delivered to the Architect.


- II. PRODUCTS A. All materials shall be new, first class, and comply with latest ASTM Specifications and Standards relating to such materials. B. Water Piping:
- 1. Furnish and install dielectric or isolation fittings at all points where copper pipe connects to wrought iron or steel pipe. 2. Exposed Pipe in Toilet Rooms: Chrome Plated Brass, American Brass Company, or equivalent. Furnish and install chrome plated wall plates. 3. Piping under floor slab shall be Type K soft temper copper tubing ASTM B-88. No joints shall be permitted under floor slab.

Piping above floor slab shall be Type L hard drawn copper tubing ASTM B-88.

- Use wrought copper sweat fittings. Sanitary Waste, and Vent Piping: Piping shall be Schedule 40 PVC - DWV pipe E. Pipe Hangers: Adjustable wrought clevis type hanger and rods; Grinnell Company or equivalent.
- F. Cleanouts: 1. Floor Cleanouts for soil and waste lines shall have bodies of standard pipe sizes as manufactured by Zurn or equivalent. 2. Wall Cleanouts for soil and waste lines shall have bodies of standard pipe sizes as manufactured by Zurn or equivalent.
- 2. Ball valves 2" and smaller. Unions shall have brass to metal ground joint seal. H. Escutcheon Plates: Provide chrome plated escutcheon plates where exposed pipe passes through walls, floors, or ceiling in finished areas. I. Pipe Insulation: 1. All hot water pipe above grade shall be insulated with 1" fiberglass, low pressure insulation with white universal jacket. Apply in accordance with manufacture's

2. All cold water pipe above grade shall be insulated with 1/2" fiberglass as above.

Butterfly valves 2-1/2" and larger.

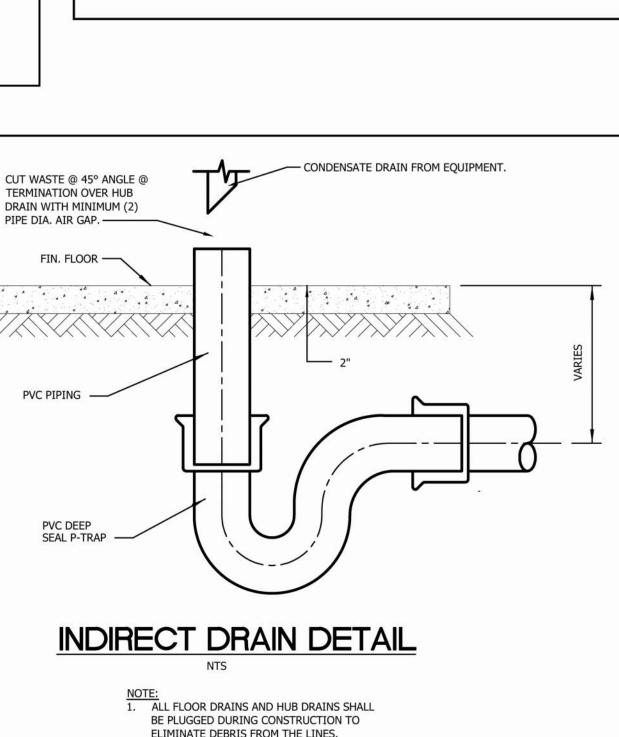

MATERIALS OF CONSTRUCTION

USDA APPROVED JACKETING.

Tube size and CTS

\*\* PEX tubing must be labeled as follows:

TUBING SHALL HAVE PEX 5006 DESIGNATION.

\_\_\_\_

The manufacturer's name or trademark

Material designation code (PEX0006)

Pressure/temperature rating(s)

SANITARY SEWER, WASTE, DRAIN & VENT ----- SCH. 40 PVC

VENTS ABOVE CEILING ----- SCH. 40 PVC

HOT & COLD WATER - ANSI, ASME, NSF CERTIFIED ----- TYPE "K" BELOW GRADE

SANITARY SEWER 5'-0" OUTSIDE BUILDING ----- PVC-ASTM D-3034

\* ALL INSULATED FITTINGS SHALL BE WRAPPED WITH ZESTON #2000 PVC,

ASTM fittings designations approved for use by the tubing manufacturer.

PEX fittings must be made of metal and must be secured with metal compression

PEX tubing may not be used for water heater connections within the first 18

The standard to which it conforms (ASTM F876, F877, AWWA C904 and/or CSA B137.5)

If the tubing is for potable water, a laboratory seal or mark attesting to suitability for potable water.

TUBING or PEX.

DRAIN HOSE

COUPLING - FOR


PLUMBING ROUGHING-IN MEASUREMENTS FOR SPACE SAVER WASHING


WB-1 WASHER STANDPIPE DETAIL


MACHINE, SUPPLY & DRAIN - MODEL BB-150TS & BB-200TS

PIPE INSTALLATION

INSULATION (COPPER AND PEX) ------ INSULATE ALL HOT & COLD WATER

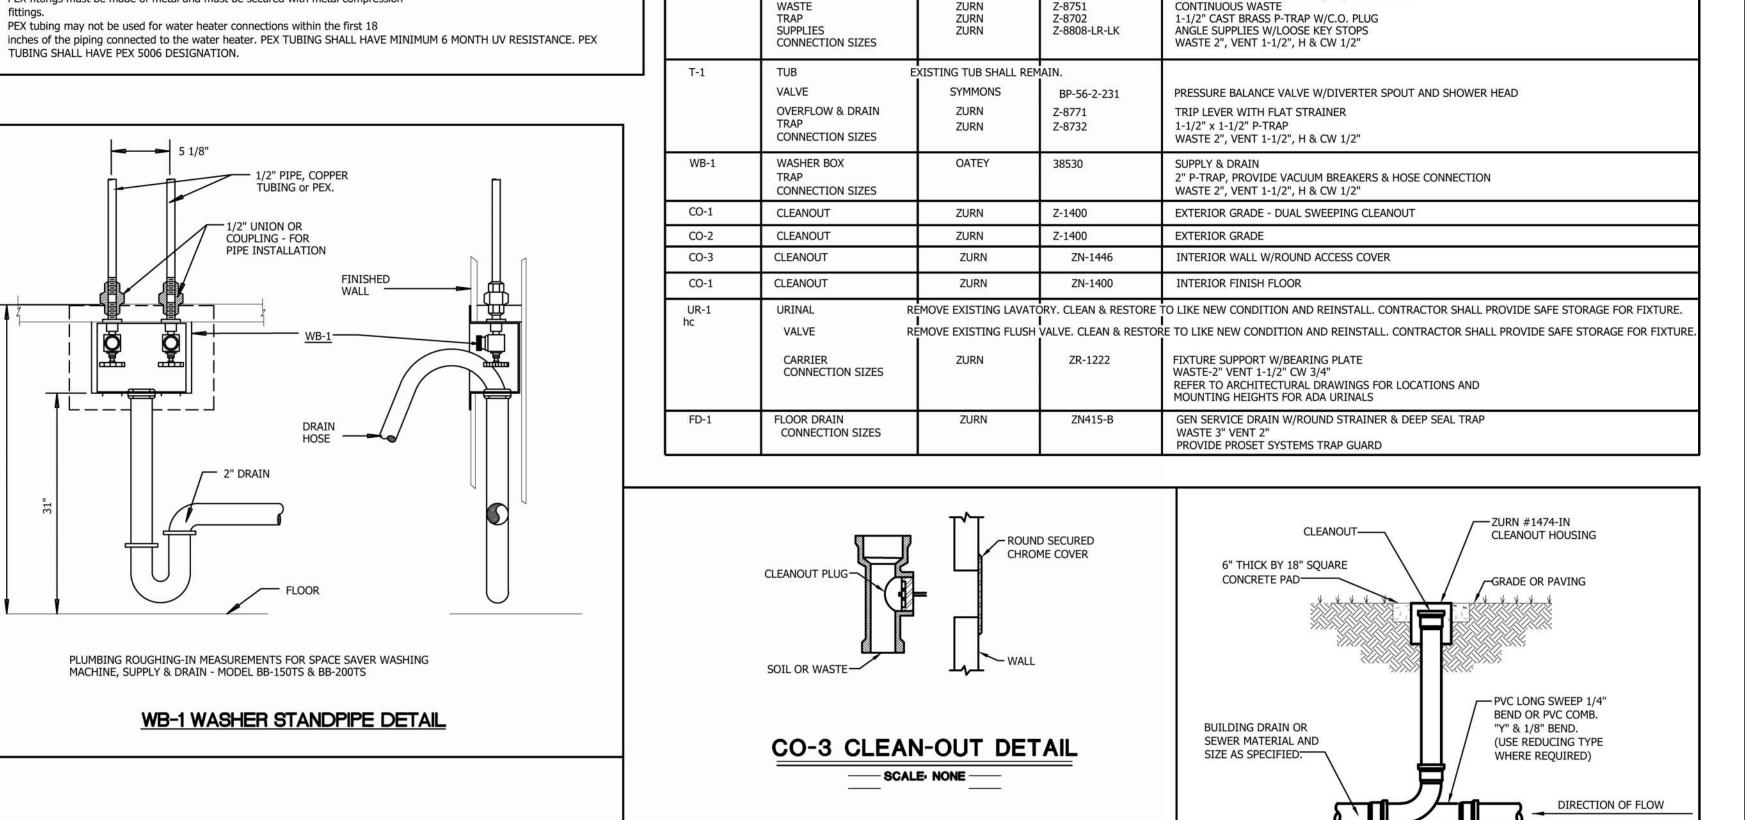

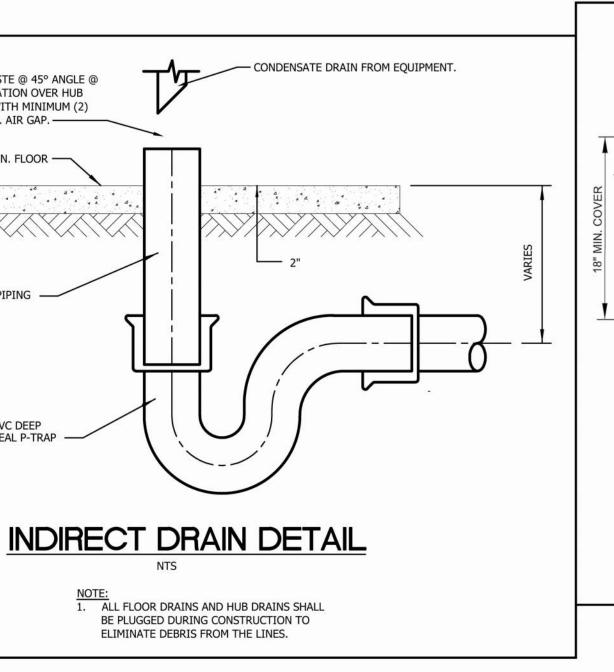

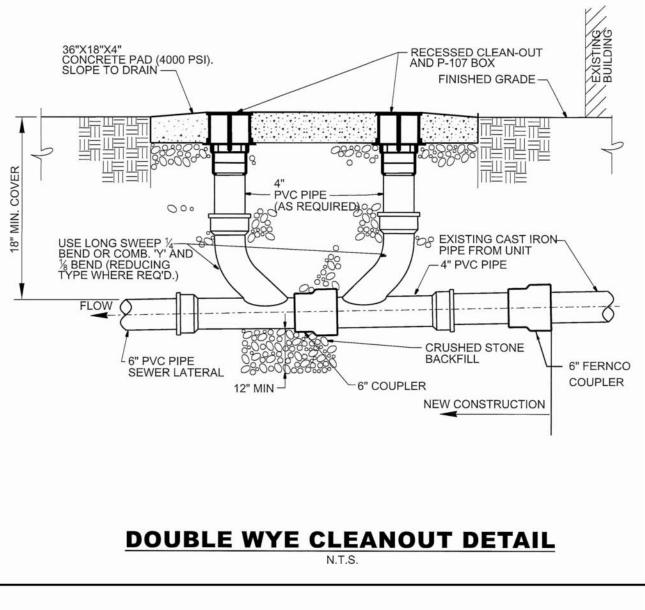

PLUMBING FIXTURE SCHEDULE

**FIXTURE TYPE** 

CONNECTION SIZES

WAX RING

LAVATORY

SUPPLIES

**FAUCET** 

INSULATION KIT

CONNECTION SIZES

FAUCET

WATER CLOSET

DESIGNATION

\*\* UNLESS NOTED OTHERWISE, ALL MODEL NUMBERS GIVEN ARE ZURN. EQUAL CHINA PRODUCTS WILL BE CONSIDERED. SIOUX CHIEF, MIFAB,

Z-8808-CR-LK

Z-8808-LR-LK

Z8946-1-NT

MODEL # DESCRIPTION

FURNISH WITH FLOOR ANCHOR BOLTS.

WAX RING - JUMBO SIZE WITH PLASTIC HORN.

REMOVE EXISTING LAVATORY. CLEAN & RESTORE TO LIKE NEW CONDITION AND REINSTALL. CONTRACTOR SHALL PROVIDE SAFE STORAGE FOR FIXTURE

REMOVE EXISTING FAUCET. CLEAN & RESTORE TO LIKE NEW CONDITION AND REINSTALL. CONTRACTOR SHALL PROVIDE SAFE STORAGE FOR FIXTURE.

ZURN TRAP WRAP, MOLDED CLOSED CELL VINYL INSULATION

1-1/2" CAST BRASS P-TRAP W/C.O. PLUG

REMOVE EXISTING SINK. CLEAN & RESTORE TO LIKE NEW CONDITION AND REINSTALL. CONTRACTOR SHALL PROVIDE SAFE STORAGE FOR FIXTURE.

REMOVE EXISTING FAUCET. CLEAN & RESTORE TO LIKE NEW CONDITION AND REINSTALL. CONTRACTOR SHALL PROVIDE SAFE STORAGE FOR FIXTURE.

STANDARD DUO STRAINER W/1-1/2" TAILPIECE

ANGLE SUPPLIES W/LOOSE KEY STOPS

WASTE 2", VENT 1-1/2", H & CW 1/2"

ANGLE SUPPLY W/LOOSE KEY STOP

WASTE-4", VENT 2", CW 1/2"


WADE, AND JR SMITH DRAIN PRODUCTS WILL BE CONSIDERED. EQUAL STAINLESS STEEL PRODUCTS WILL BE CONSIDERED.

MANUFACTURER

Oatey

ZURN

ZURN

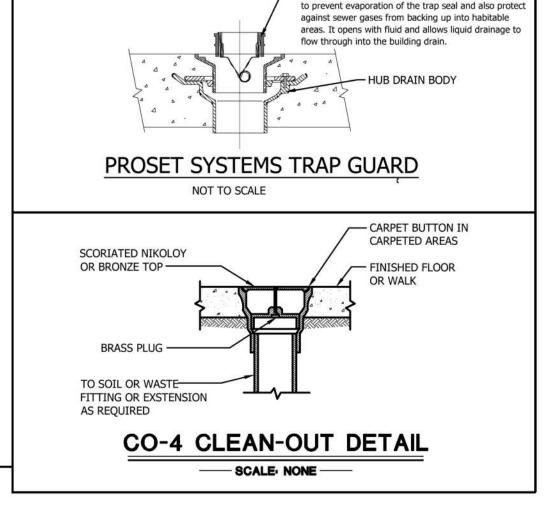

CO-1 & CO-2 GRADE CLEAN-OUT DETAIL

- PROSET SYSTEMS An ELASTOMERIC, Normally

Closed Trap Guard Device utilizes a normally closed se-

Drawing No.